


DEPARTMENT OF NATURAL RESOURCES WYANDOTTE CAVE (LARGE)

CITY OF LEAVENWORTH, INDIANA

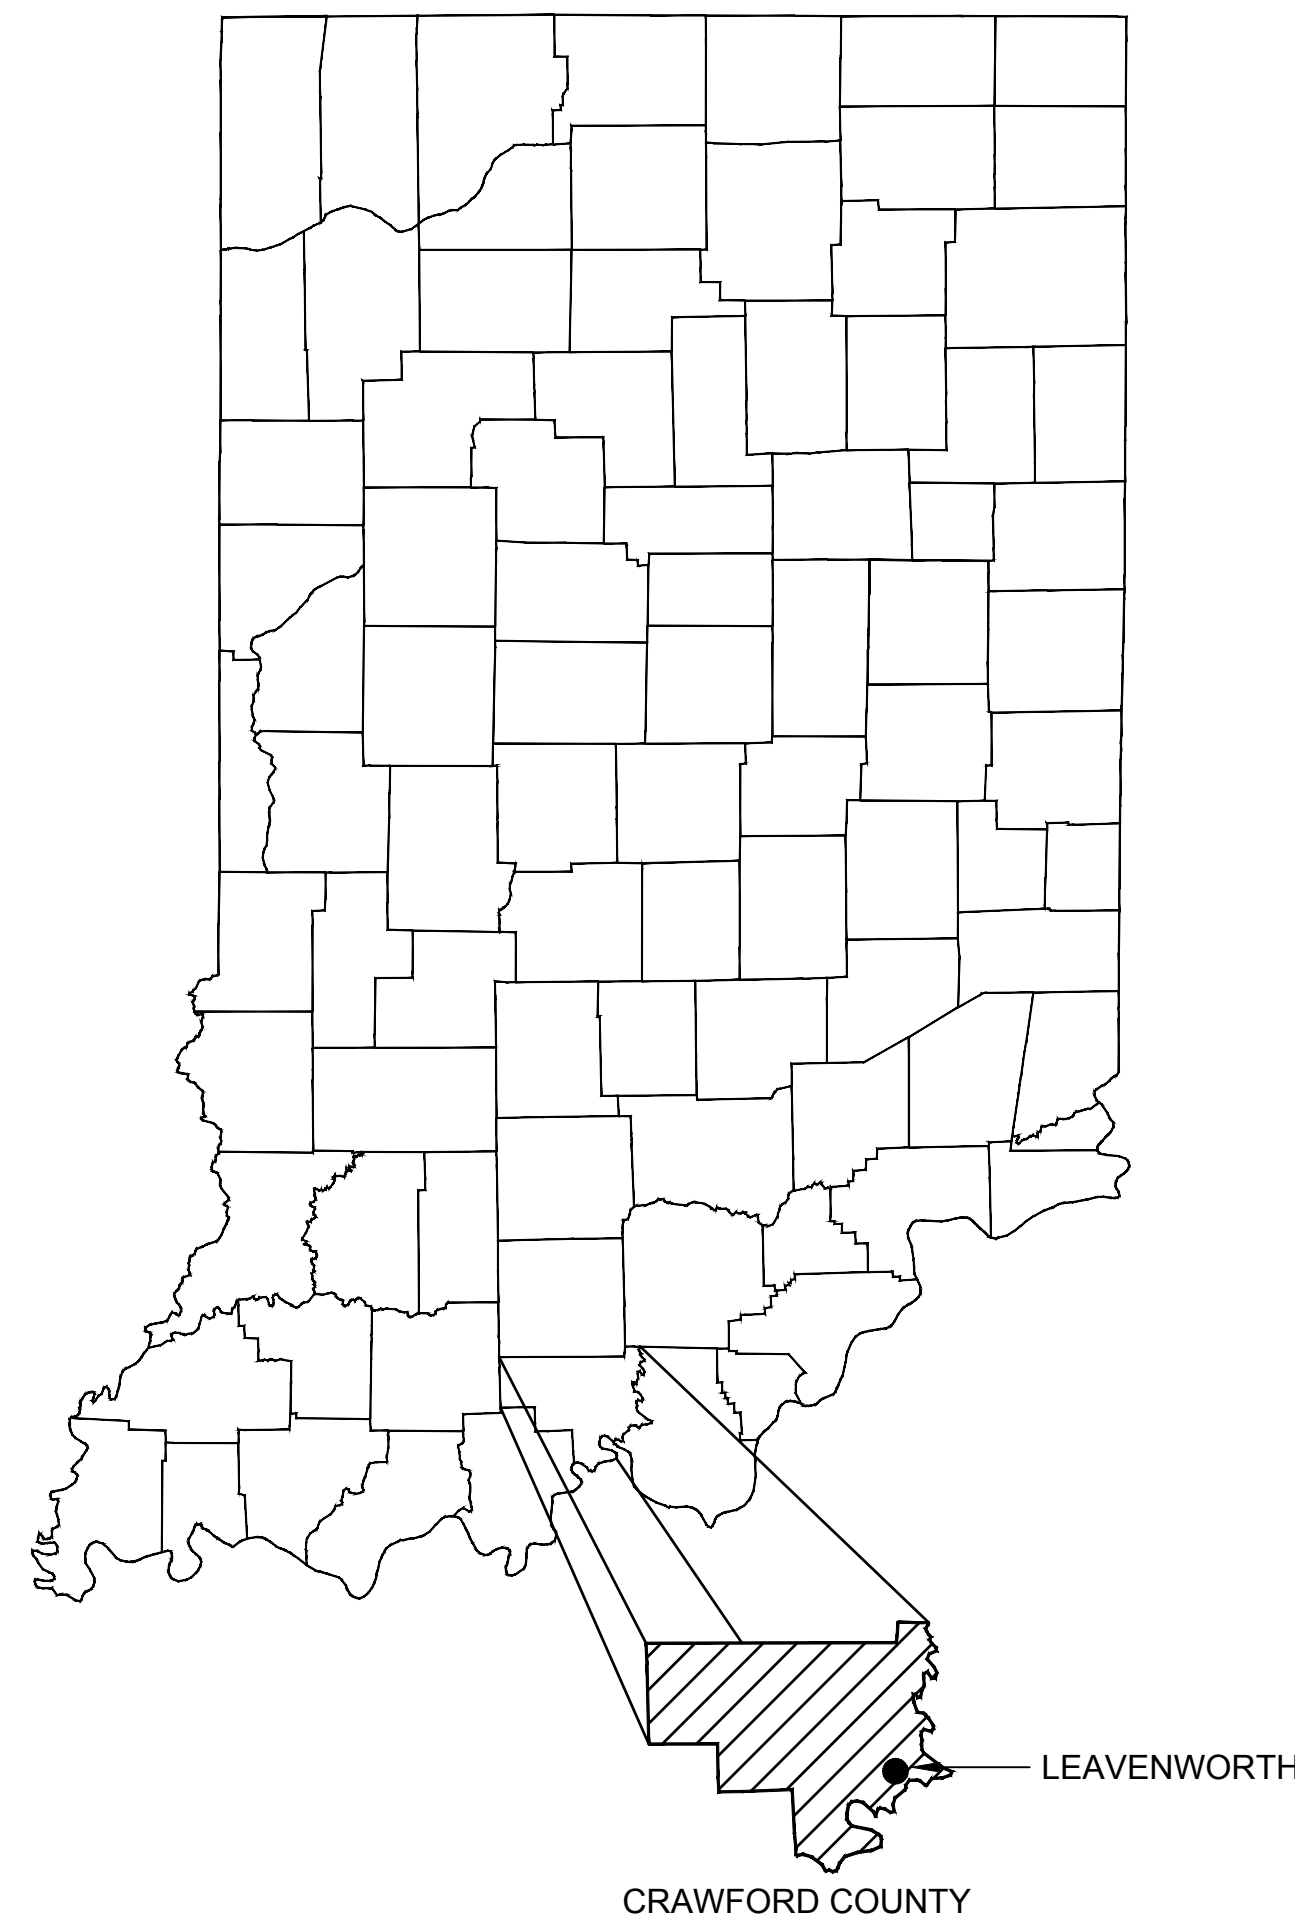

engineering | architecture | geospatial

www.grwinc.com

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E-502	ELECTRICAL DETAILS II
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E-602	PANEL BOARD SCHEDULES


BID DOCUMENTS

SEPTEMBER, 2018

GRW PROJECT NO. 4495-25

GENERAL NOTES:

1. THE PARK STAFF HAVE SPENT A LOT OF TIME AND MONEY TO MAKE ARTIFICIAL SHROUDS, COVERS, GROUTING, STACKING ROCKS AND OTHER EFFORTS TO CONCEAL THE ELECTRICAL WORK AND HAVE THE CAVE APPEAR IN ITS NATURAL STATE AS MUCH AS POSSIBLE. THE WORK OF THIS CONTRACT SHALL PRESERVE AS MUCH OF THEIR EFFORTS AS POSSIBLE. PARK STAFF SHALL RECONCEAL THE ELECTRICAL WORK AFTER MODIFICATIONS ARE COMPLETED, AS LONG AS THE CONTRACTOR IS MAKING EFFORTS TO MINIMIZE THE DAMAGE TO EXISTING CONDITIONS.

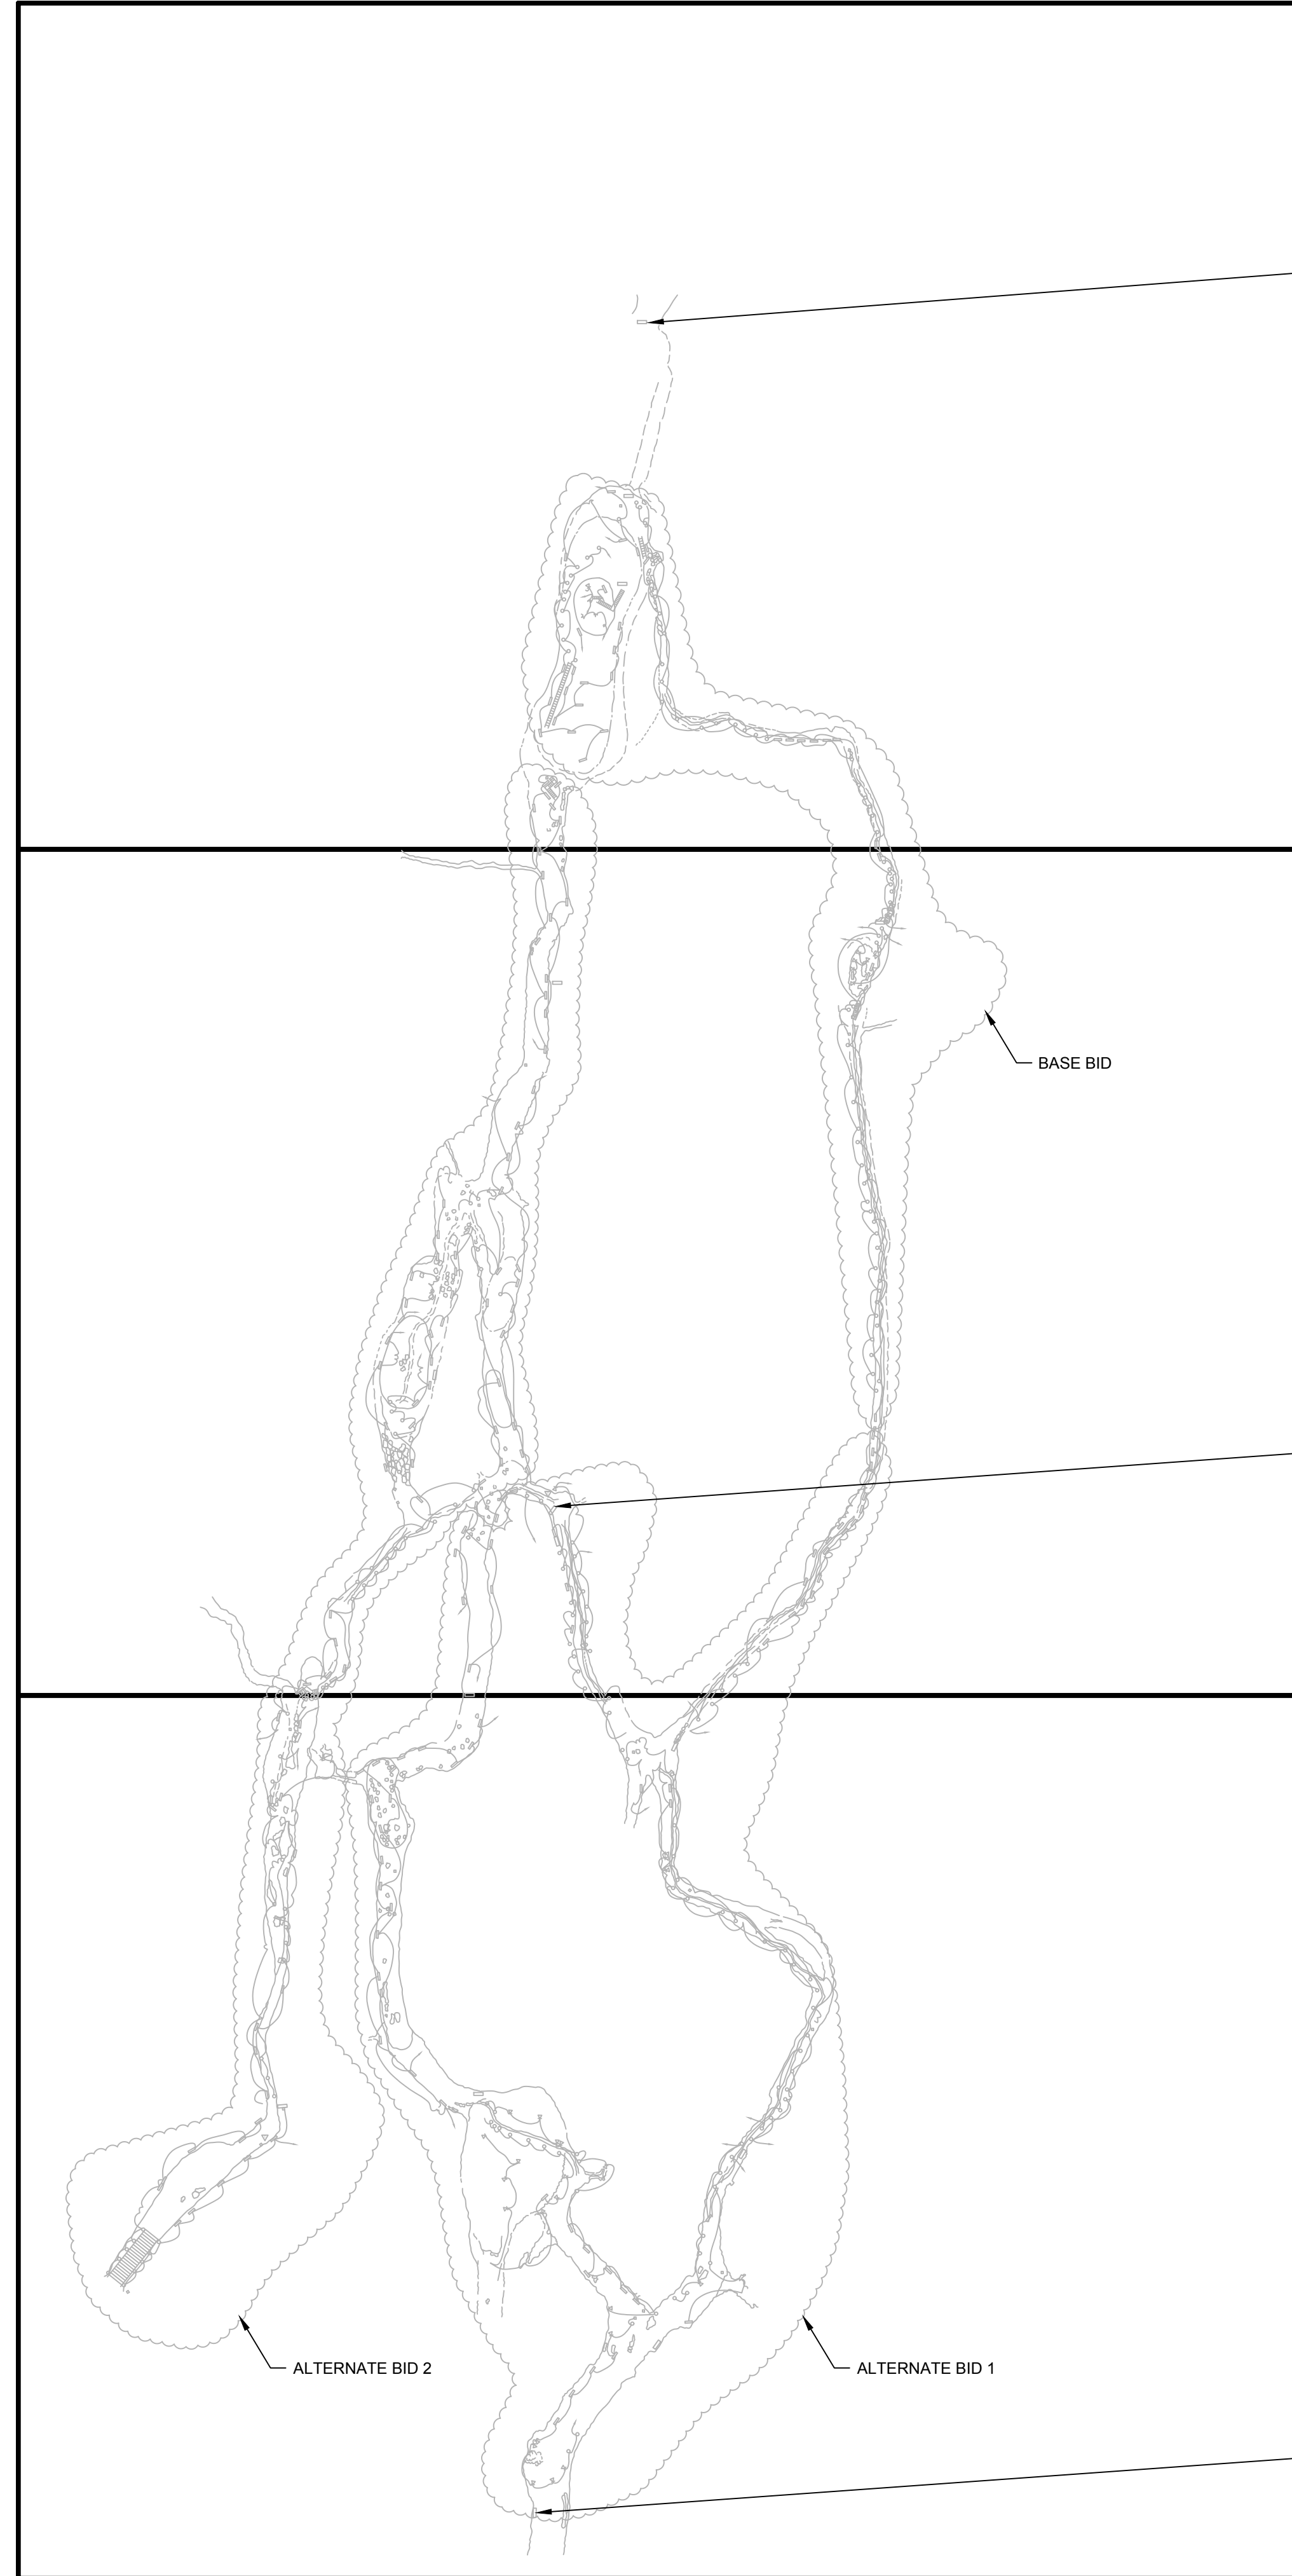

WYANDOTTE CAVE

SCALE: 1"=60'-0" 0 60 120'


ELECTRIC SERVICE FOR
BASE BID WORK ON
SURFACE ABOVE CAVE
IN THIS APPROXIMATE
LOCATION

ELECTRIC SERVICE FOR
ALTERNATE BID 2 WORK
ON SURFACE ABOVE
CAVE IN THIS
APPROXIMATE
LOCATION

ELECTRIC SERVICE FOR
ALTERNATE BID 1 WORK
ON SURFACE ABOVE
CAVE IN THE
SEISMOGRAPH BUILDING



GRW PROJECT NO. 4495-25
CLIENT PROJECT NO. XXXX
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**WYANDOTTE CAVE -
OVERALL KEY PLAN
WYANDOTTE CAVE (LARGE)
LEAVENWORTH, INDIANA**

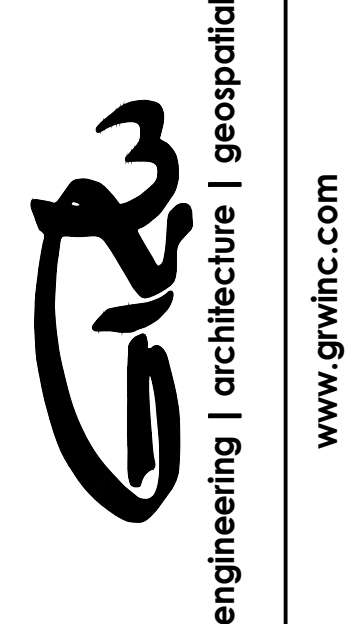DESIGNED:	DRC
DRAWN:	RHR
REVIEWED:	WLM
APPROVED:	WLM

NO.	REVISIONS DESCRIPTION	DATE	BY

SCALE CHECK: _____ THIS MARK SHOULD MEASURE EXACTLY 1" WHEN PLOTTED


DATE: SEPTEMBER 2018
SCALE: 1"=60'

SHEET NO. E-101

PLOTTED BY: bramsey

PRINTED: 9/26/2018 @ 8:58AM

FILE NAME: G:\485-IDNR-Bat Cave\Working Drawings\AutoCAD\Large Cave\4495-E-401.dwg

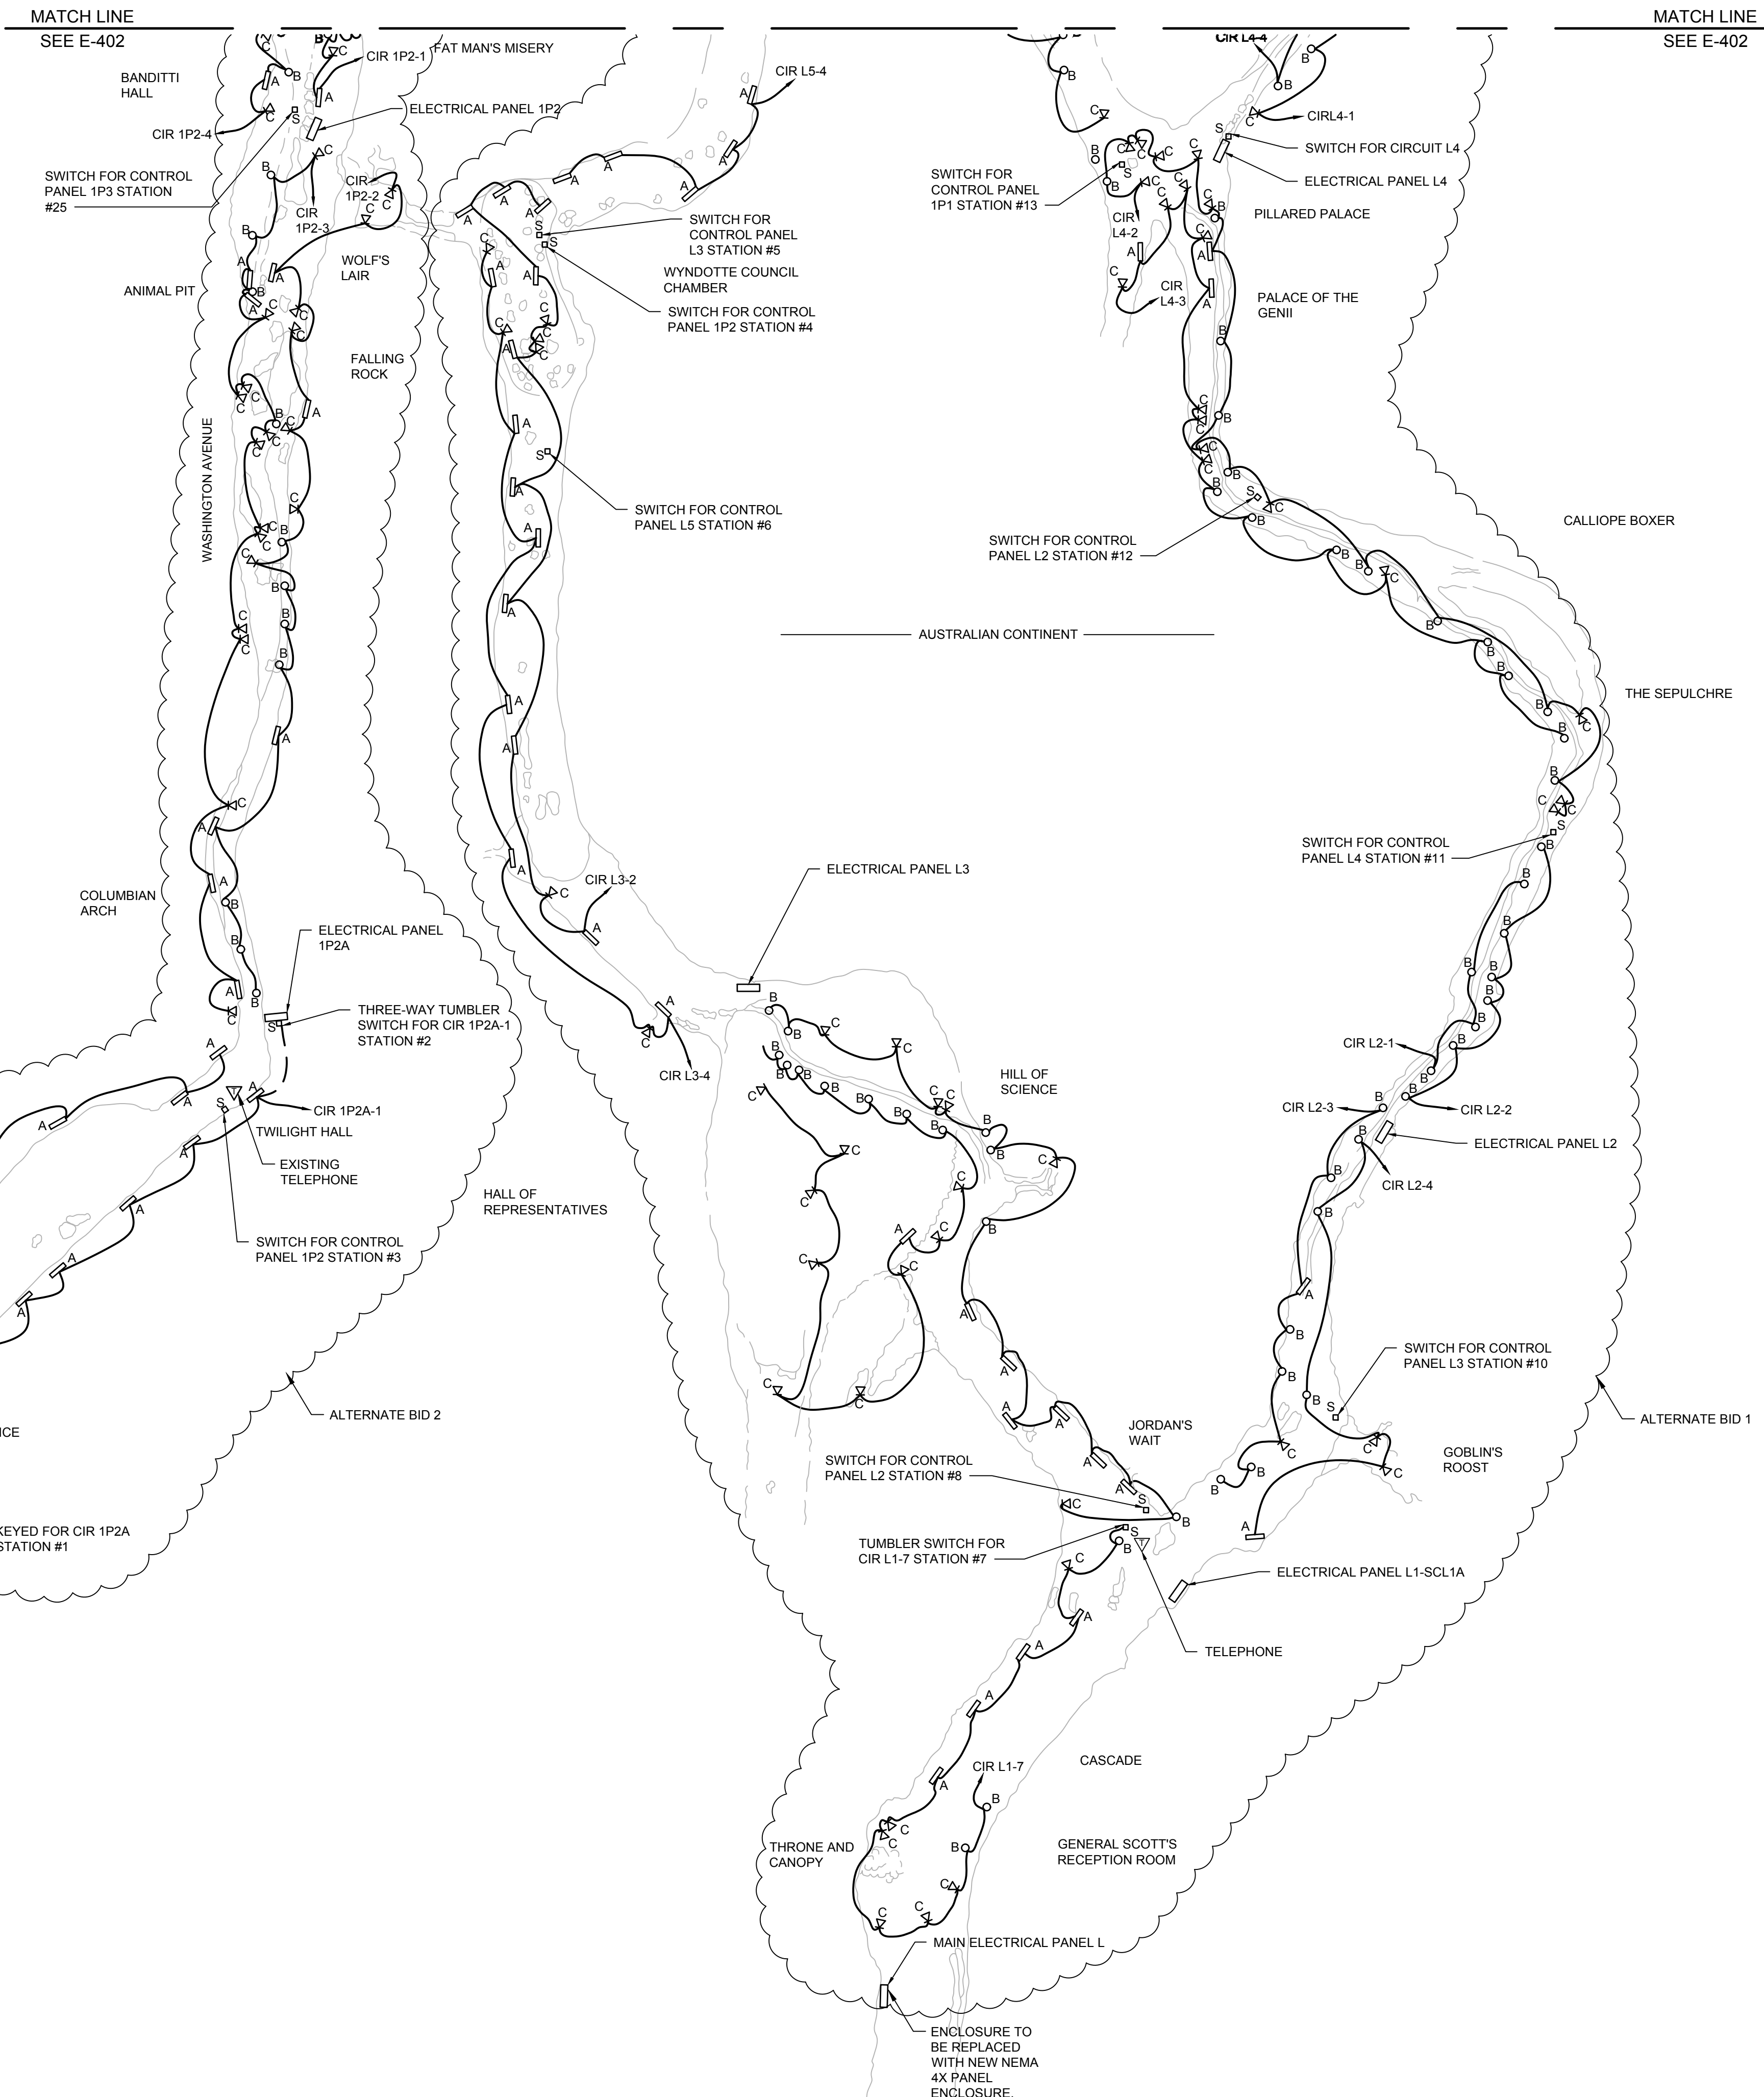

SYMBOLS:

- EXISTING STRIP
- A FLUORESCENT FIXTURE
- B EXISTING FLOOD LIGHT
- C EXISTING AIMABLE FLOOD LIGHT
- D LED STEP LIGHT
- EXISTING LIGHT SWITCH
- EXISTING LIGHTING CONTROL PANEL
- RUN OF 12-2 W GROUND COPPER GRAY JACKETED NM CABLE (TYPICAL)


GENERAL NOTE:

1. ALL A, B, C, AND D DESIGNATED EXISTING LIGHT FIXTURES ON THIS DRAWING SHALL BE REMOVED AND REPLACED.
2. ALL EXISTING ELECTRICAL LIGHTING WIRING SHALL BE REMOVED AND REPLACED.
3. ALL EXISTING WIRE IN CONDUIT BETWEEN FEEDERS TO REMAIN.
4. ALL EXISTING TELEPHONES SHALL BE REMOVED.
5. ALL NM CABLE SHALL BE REMOVED THROUGHOUT THE CAVE.
6. ALL EXISTING PANELS SHALL REMAIN UNLESS OTHERWISE NOTED.
7. ALL EXISTING SWITCHES AND PUSHBUTTON CONTROLS TO BE REPLACED IN KIND.

WYANDOTTE CAVE LOST RIVULET
 SCALE: 1"=20'-0" 0 20' 40'



GRW PROJECT NO. 4495-25
 CLIENT PROJECT NO. XXXX
 ALL RIGHTS RESERVED. NO PART OF THIS DRAWING SHALL BE REPRODUCED IN WHOLE OR IN PART WITHOUT WRITTEN PERMISSION.

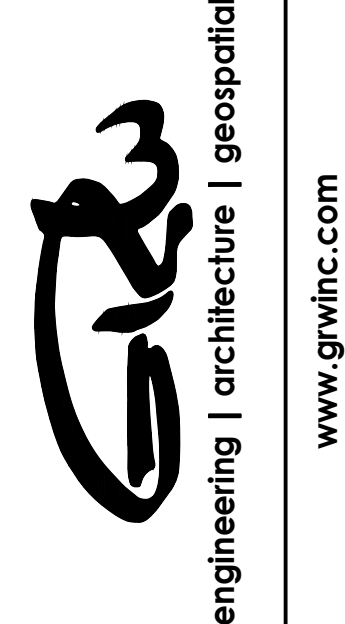

**WYANDOTTE CAVE -
 ENTRANCE OF CAVE DEMOLITION
 WYANDOTTE CAVE (LARGE)
 LEAVENWORTH, INDIANA**

DESIGNED	DRC	DRAWN	RHR	REVIEWED	WLM	APPROVED	WLM
----------	-----	-------	-----	----------	-----	----------	-----

NO.	REVISIONS	DATE	BY
	DESCRIPTION		

DATE: SEPTEMBER 2018
 SCALE: 1"=20'
 SHEET NO.

E-401

BID DOCUMENTS

PLOTTED BY: bramsey

PRINTED: 9/26/2018 @ 8:59AM

FILE NAME: G:\4495-IDNR-Bat Cave\Working Drawings\AutoCAD\Large Cave\4495-E-402.dwg

MATCH LINE
SEE E-403


MATCH LINE
SEE E-403

SYMBOLS:

- STRIP FLUORESCENT FIXTURE
- FLOOD LIGHT
- △ AIMABLE FLOOD LIGHT
- LED STEP LIGHT
- LIGHT SWITCH
- LIGHTING CONTROL PANEL
- RUN OF 12-2 W/ GROUND COPPER GRAY JACKETED NM CABLE (TYPICAL)

GENERAL NOTE:

1. ALL A, B, C, AND D DESIGNATED EXISTING LIGHT FIXTURES ON THIS DRAWING SHALL BE REMOVED AND REPLACED.
2. ALL EXISTING ELECTRICAL LIGHTING WIRING SHALL BE REMOVED AND REPLACED.
3. ALL EXISTING WIRE IN CONDUIT BETWEEN FEEDERS TO REMAIN.
4. ALL EXISTING TELEPHONES SHALL BE REMOVED.
5. ALL NM CABLE SHALL BE REMOVED THROUGHOUT THE CAVE.
6. ALL EXISTING PANELS SHALL REMAIN UNLESS OTHERWISE NOTED.
7. ALL EXISTING SWITCHES AND PUSHBUTTON CONTROLS TO BE REPLACED IN KIND.

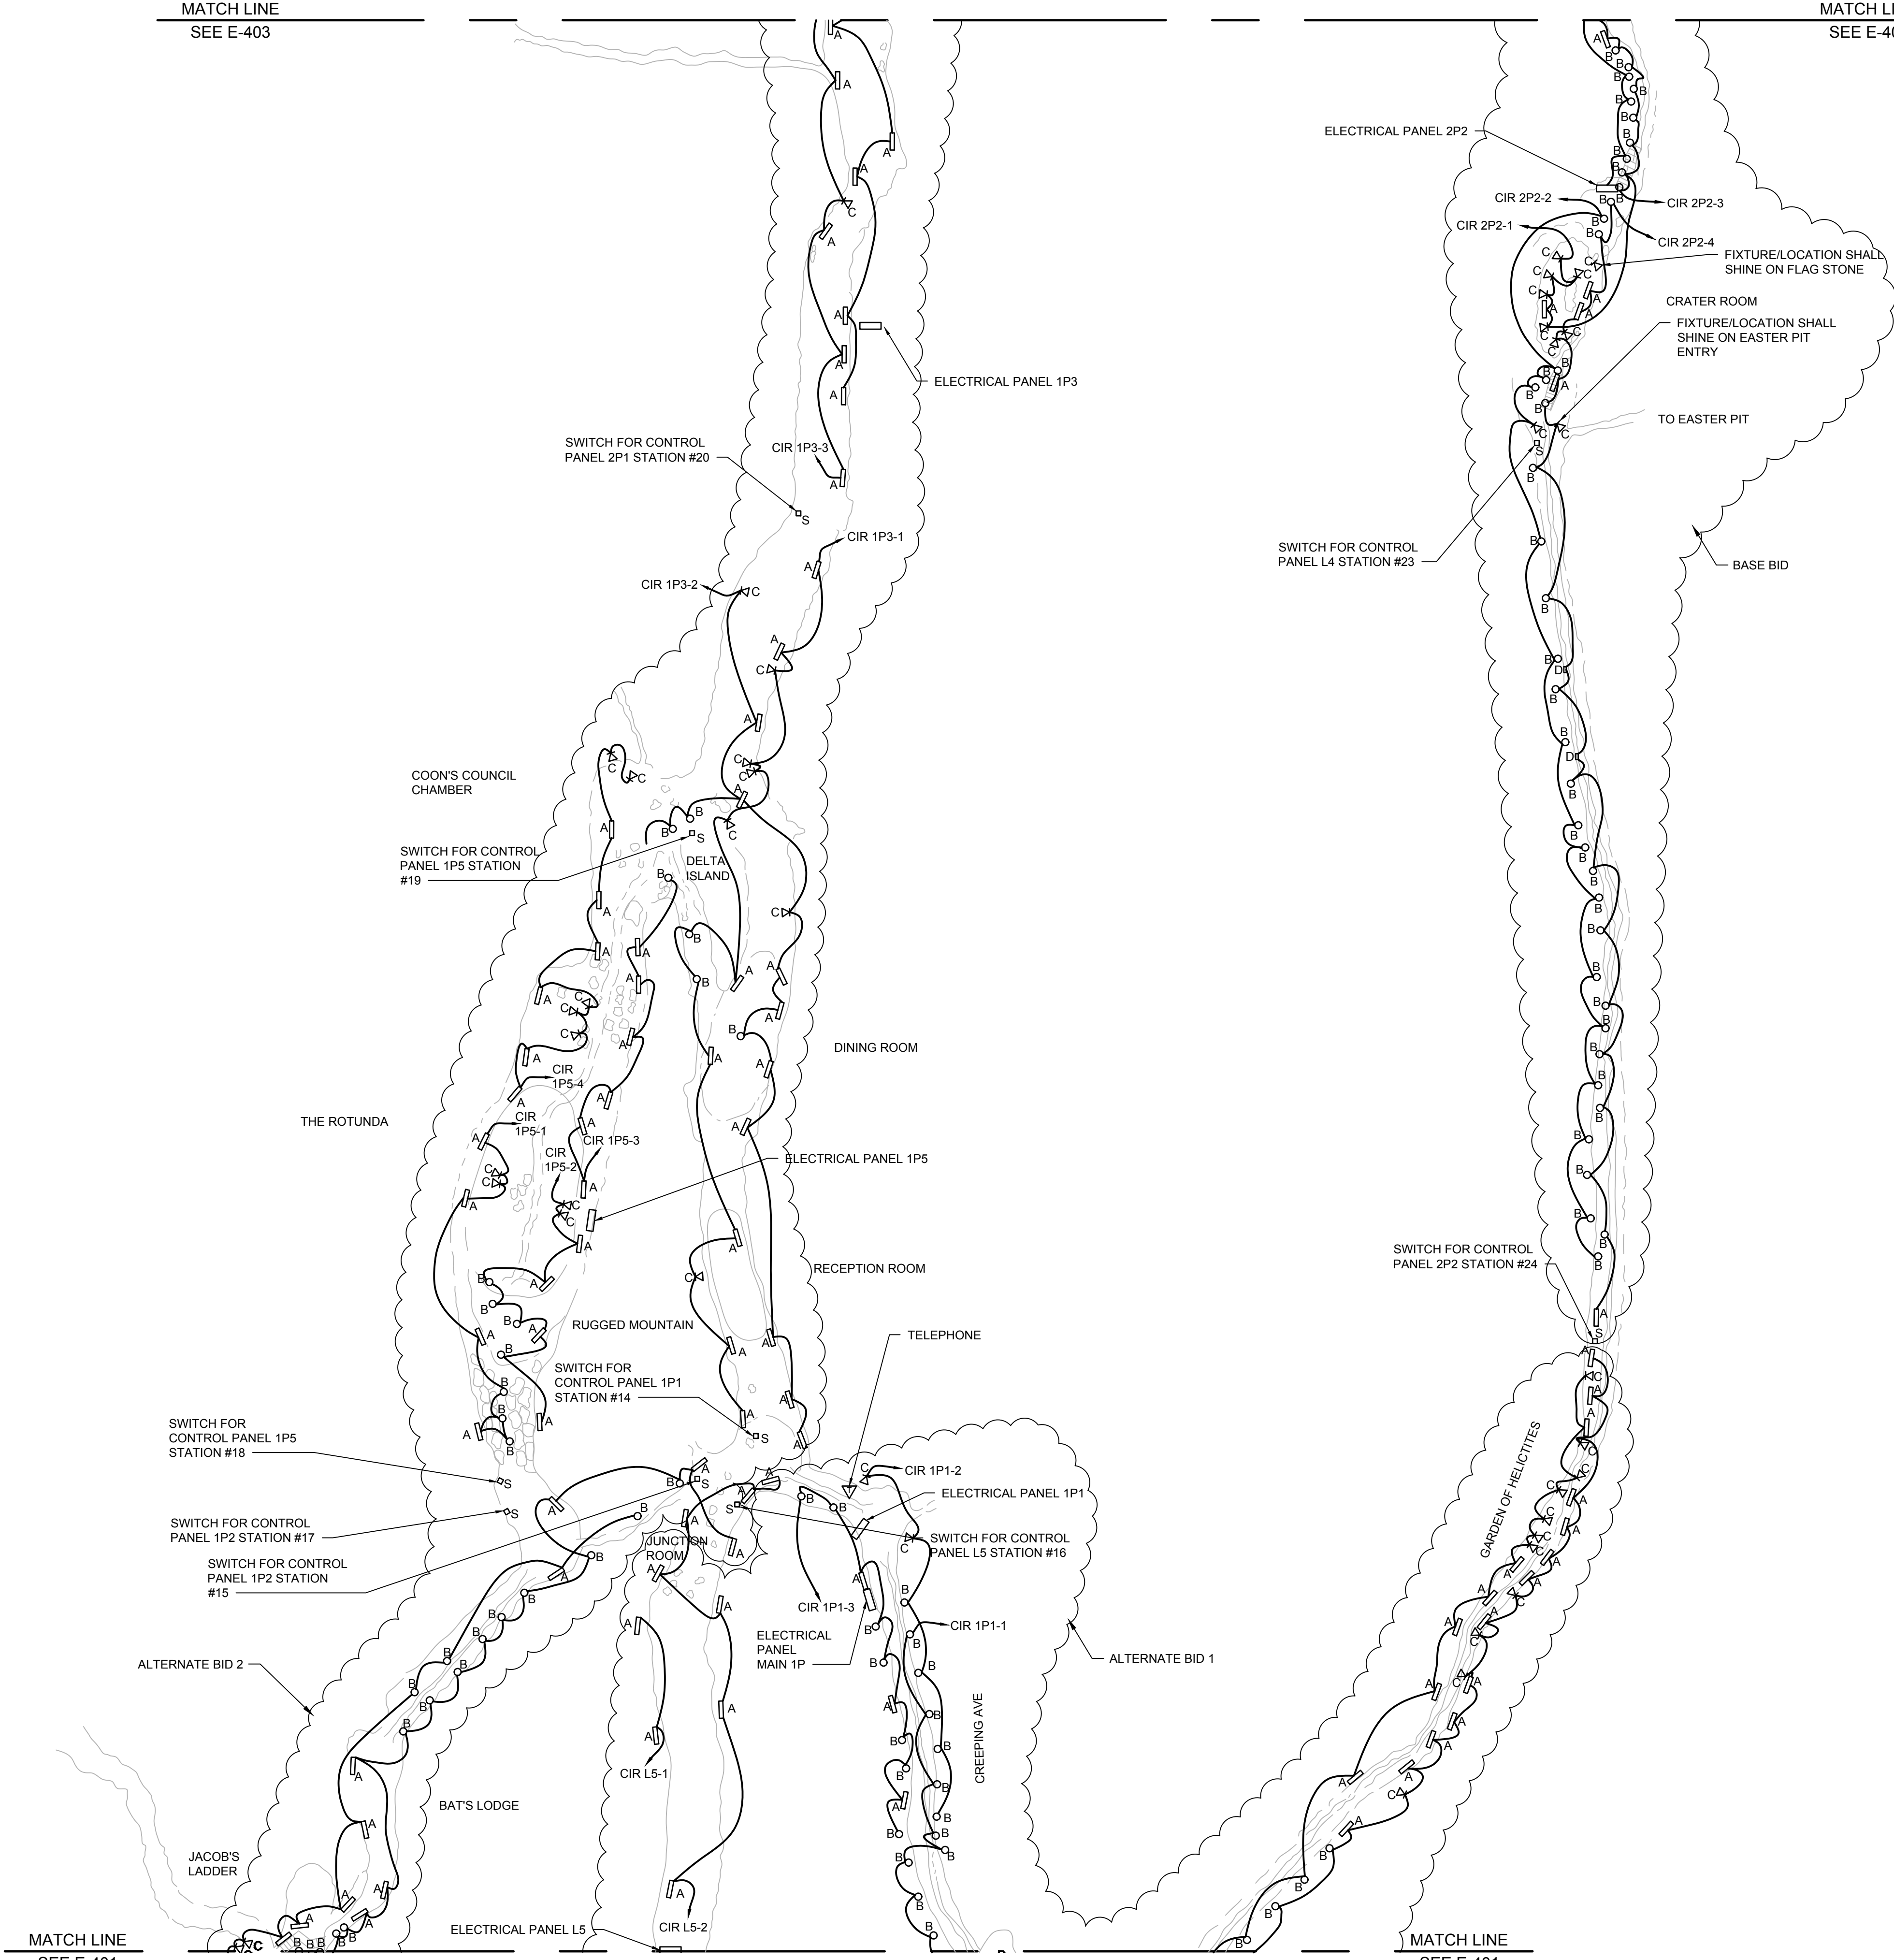


WYANDOTTE CAVE

SCALE: 1"=20'-0" 0 20' 40'



GRW PROJECT NO. 4495-25
 CLIENT PROJECT NO. XXXX
 ALL RIGHTS RESERVED. NO PART OF THIS DRAWING SHALL BE REPRODUCED IN WHOLE OR IN PART WITHOUT WRITTEN PERMISSION.

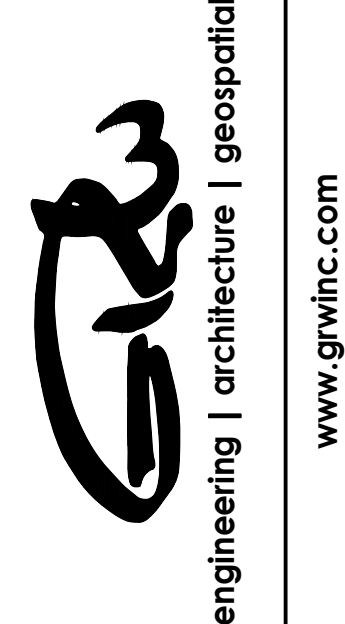

**WYANDOTTE CAVE -
 MIDDLE OF CAVE DEMOLITION
 WYANDOTTE CAVE (LARGE)
 LEAVENWORTH, INDIANA**

DESIGNED	DRC	DRAWN	RHR	REVIEWED	WLM	APPROVED	WLM
----------	-----	-------	-----	----------	-----	----------	-----

NO.	REVISIONS	DATE	BY


DATE: SEPTEMBER 2018
 SCALE: 1"=20'
 SHEET NO.

E-402

BID DOCUMENTS



GRW PROJECT NO. 4485-25
CLIENT PROJECT NO. XXXX
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WYANDOTTE CAVE - END OF CAVE DEMOLITION WYANDOTTE CAVE (LARGE) LEAVENWORTH, INDIANA

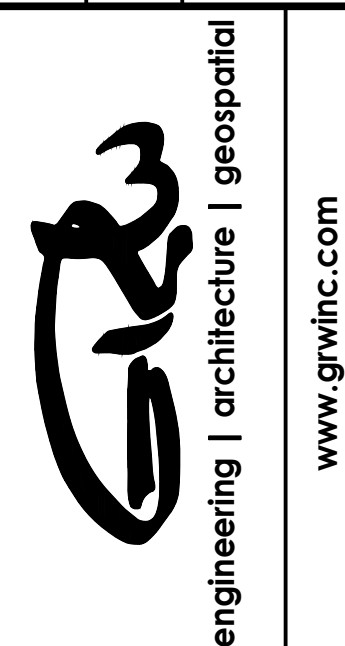DESIGNED	DRC
DRAWN	RHR
REVIEWED	WLM
APPROVED	WLM

NO.	REVISIONS	DATE	BY

DATE: SEPTEMBER 2018
SCALE: 1"=20'
SHEET NO.


E-403

SYMBOLS:

- STRIP FLUORESCENT FIXTURE
- FLOOD LIGHT
- AIMABLE FLOOD LIGHT
- LED STEP LIGHT
- LIGHT SWITCH
- LIGHTING CONTROL PANEL
- RUN OF 12-2 W/ GROUND COPPER GRAY JACKETED NM CABLE (TYPICAL)


GENERAL NOTE:

1. ALL A, B, C, AND D DESIGNATED EXISTING LIGHT FIXTURES ON THIS DRAWING SHALL BE REMOVED AND REPLACED.
2. ALL EXISTING ELECTRICAL LIGHTING WIRING SHALL BE REMOVED AND REPLACED.
3. ALL EXISTING WIRE IN CONDUIT BETWEEN FEEDERS TO REMAIN.
4. ALL EXISTING TELEPHONES SHALL BE REMOVED.
5. ALL NM CABLE SHALL BE REMOVED THROUGHOUT THE CAVE.
6. ALL EXISTING PANELS SHALL REMAIN UNLESS OTHERWISE NOTED.
7. ALL EXISTING SWITCHES AND PUSHBUTTON CONTROLS TO BE REPLACED IN KIND.

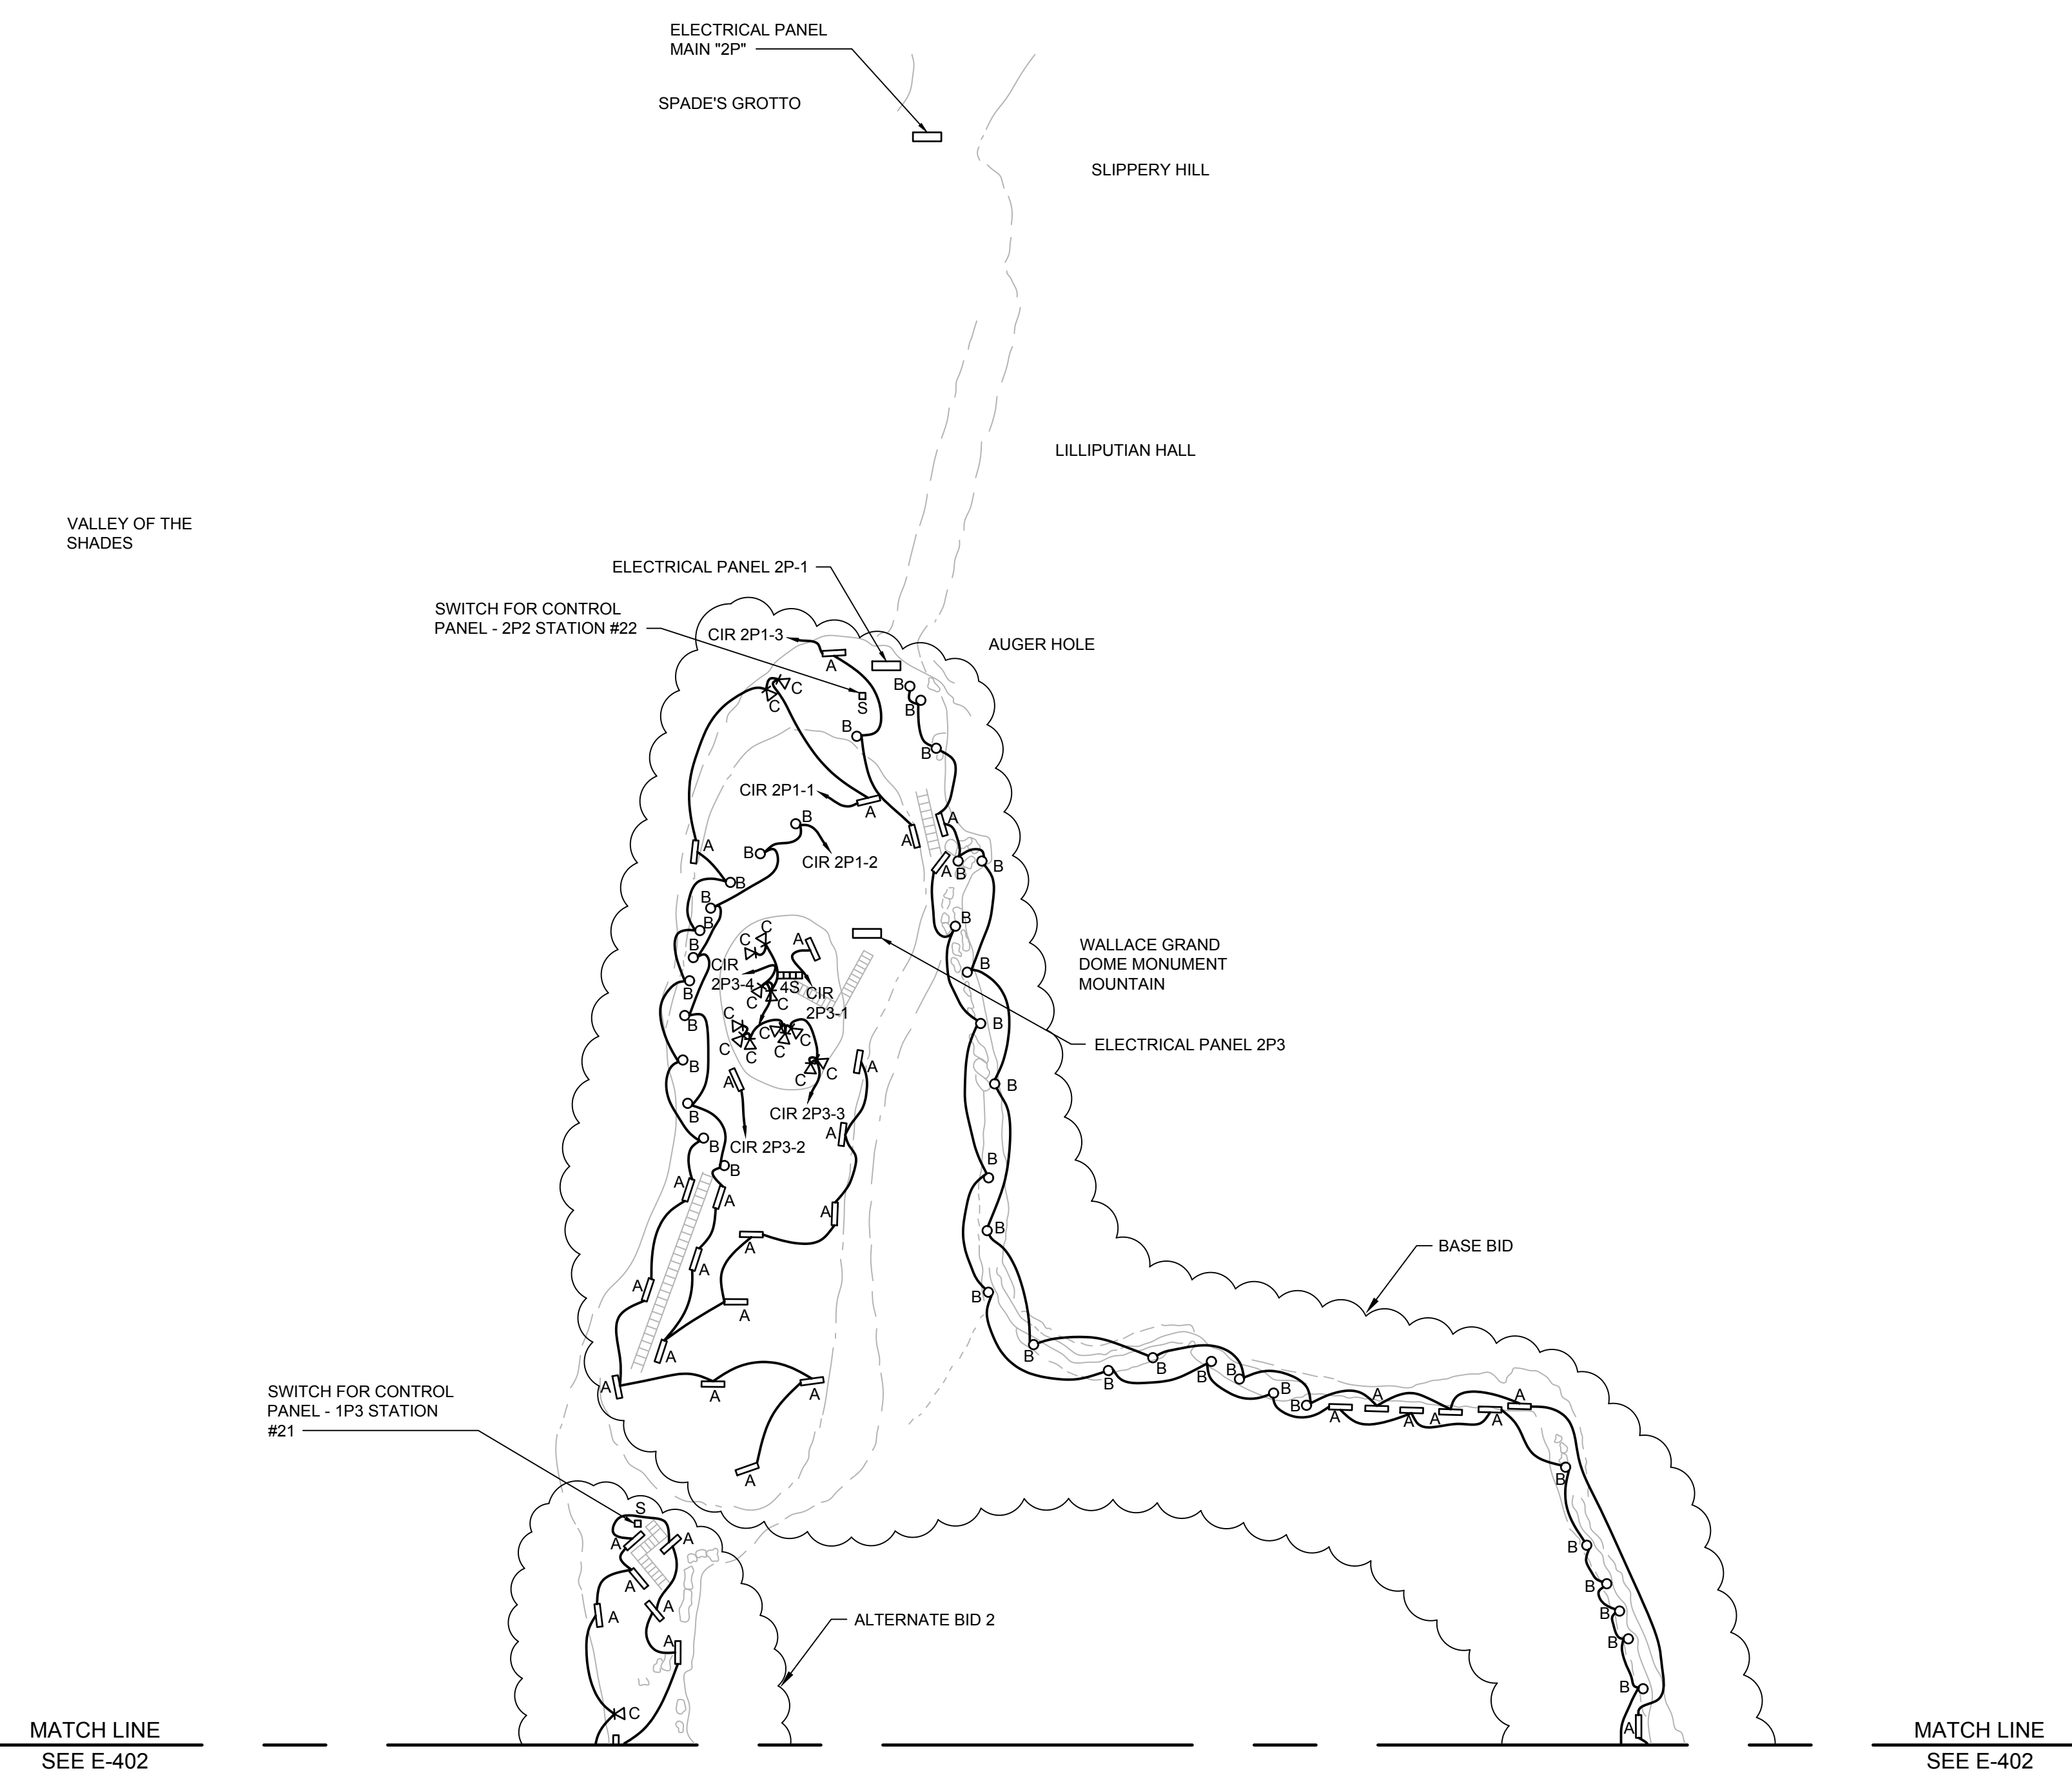

WYANDOTTE CAVE

SCALE: 1"=20'-0"

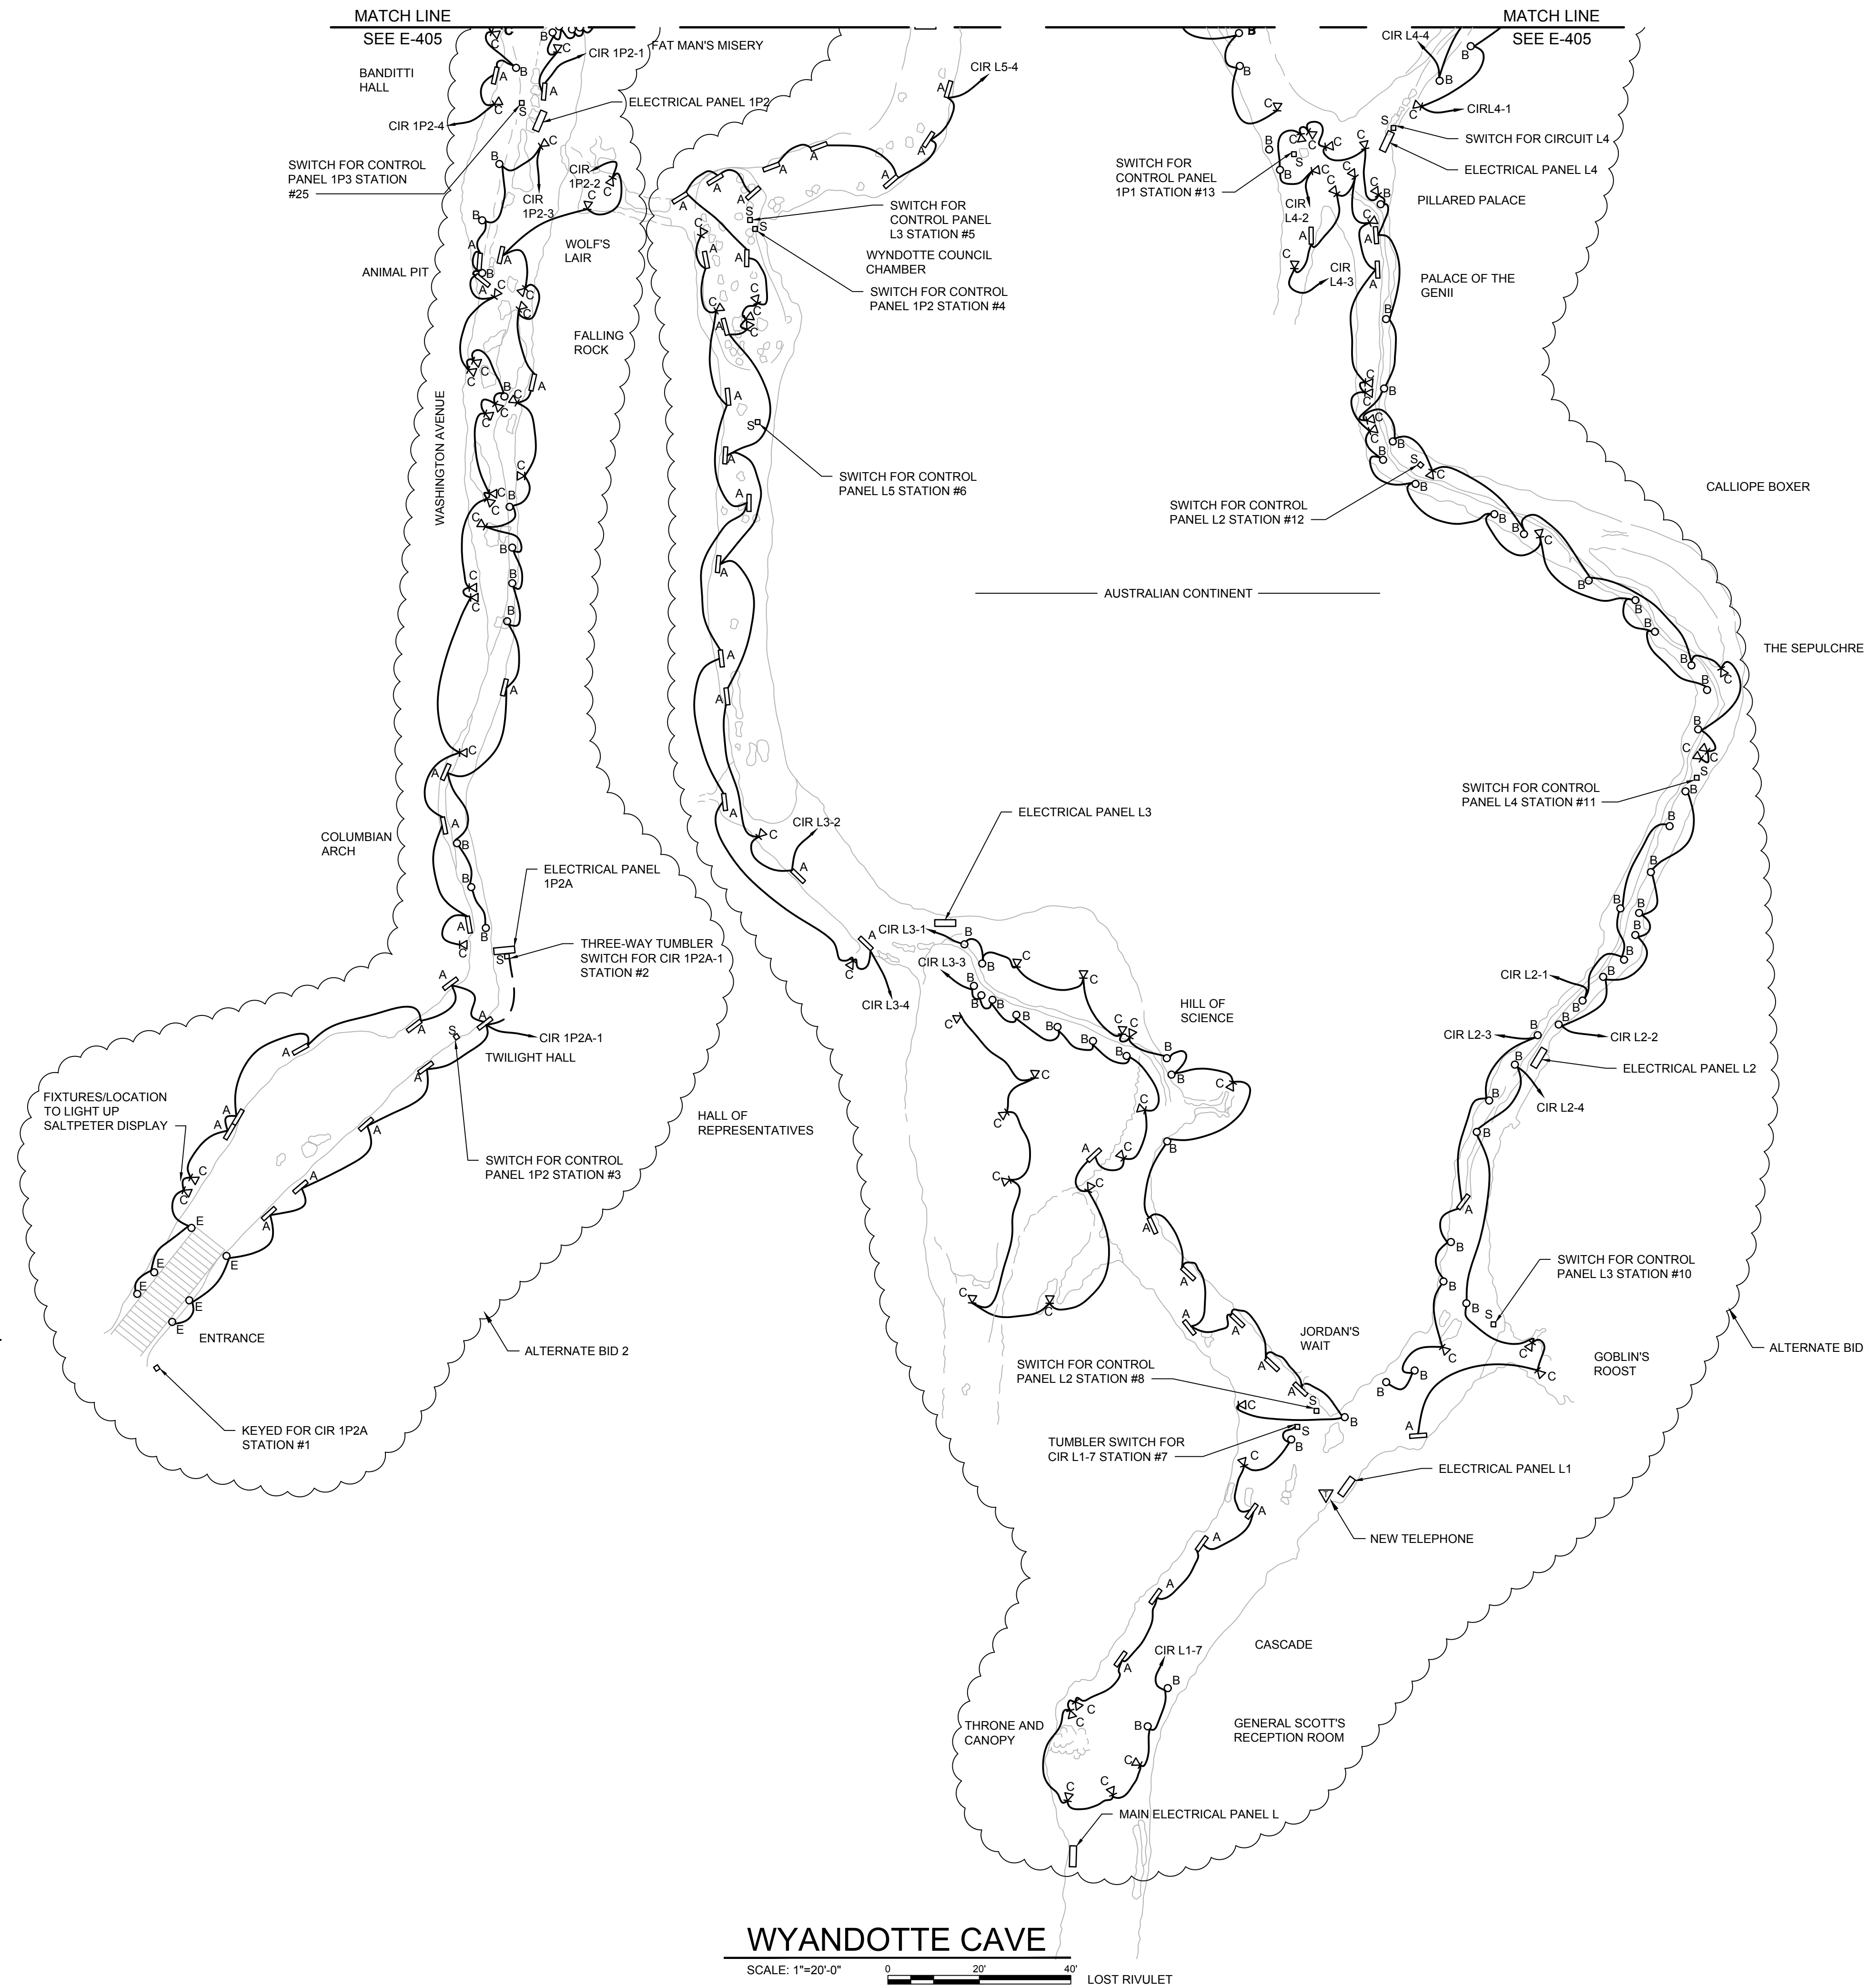

SYMBOLS:

- 1x8 LED LIGHT
- LED FLOOD LIGHT
- △ LED AIMABLE FLOOD LIGHT
- LED POLE LIGHT
- LIGHT SWITCH
- LIGHTING CONTROL PANEL
- RUN OF 12-2 W/ GROUND COPPER GRAY JACKETED UF CABLE (TYPICAL)

GENERAL NOTE:


1. ALL A, B, C, AND E DESIGNATED LIGHT FIXTURES ON THIS DRAWING ARE NEW TO BE INSTALLED THIS CONTRACT.
2. ALL NEW ELECTRICAL LIGHTING WIRING SHALL BE #12, #14 GND JACKETED UF CABLE.
3. ALL NEW TELEPHONES SHALL BE GAI-TRONICS IN NEMA 4X ENCLOSURES. ALL TELEPHONES SHALL BE MOUNTED TO UNISTRUT AT LOCATIONS SHOWN IN THE SHEETS.
4. FEEDERS BETWEEN PANELS SHOWN ON SHEET E-407.
5. ALL NEW WIRING FOR SWITCHES/BUSHBUTTONS SHALL MATCH EXISTING WIRING USING NEW UF CABLE.
6. ALL ELECTRICAL PANELS ARE EXISTING.

WYANDOTTE CAVE

SCALE: 1"=20'-0" 0 20' 40' LOST RIVULET



GRW PROJECT NO. 4495-25
 CLIENT PROJECT NO. XXXX
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**WYANDOTTE CAVE -
 ENTRANCE OF CAVE NEW LIGHTING
 WYANDOTTE CAVE (LARGE)
 LEAVENWORTH, INDIANA**

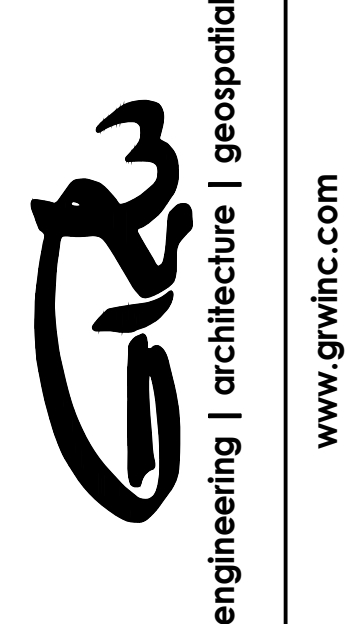DESIGNED	DRC
DRAWN	RHR
REVIEWED	WLM
APPROVED	WLM

NO.	REVISIONS	DATE	BY
	DESCRIPTION		

DATE: SEPTEMBER 2018
 SCALE: 1"=20'
 SHEET NO.

E-404

PLOTTED BY: bramsey

PRINTED: 9/26/2018 @ 8:59AM

FILE NAME: G:\485\INR-Bat Cave\Working Drawings\AutoCAD\Large Cave\4495-E-405.dwg

MATCH LINE
SEE E-203


MATCH LINE
SEE E-203

SYMBOLS:

- 1X8 LED LIGHT
- LED FLOOD LIGHT
- △ LED AIMABLE FLOOD LIGHT
- LED STEP LIGHT
- LIGHT SWITCH
- LIGHTING CONTROL PANEL
- RUN OF 12-2 W/ GROUND COPPER GRAY JACKETED UF CABLE (TYPICAL)

GENERAL NOTE:

1. ALL A, B, C, AND D DESIGNATED LIGHT FIXTURES ON THIS DRAWING ARE NEW TO BE INSTALLED THIS CONTRACT.
2. ALL NEW ELECTRICAL LIGHTING WIRING SHALL BE 2#12, 1#12 GND JACKETED UF CABLE.
3. ALL NEW TELEPHONES SHALL BE GAL-TRONICS IN NEMA 4X ENCLOSURES. ALL TELEPHONES SHALL BE MOUNTED TO UNISTRUT AT LOCATIONS SHOWN IN THE SHEETS.
4. FEEDERS BETWEEN PANELS SHOWN ON SHEET E-408.
5. ALL NEW WIRING FOR SWITCHES/BUSHBUTTONS SHALL MATCH EXISTING WIRING USING NEW UF CABLE.
6. ALL ELECTRICAL PANELS ARE EXISTING.

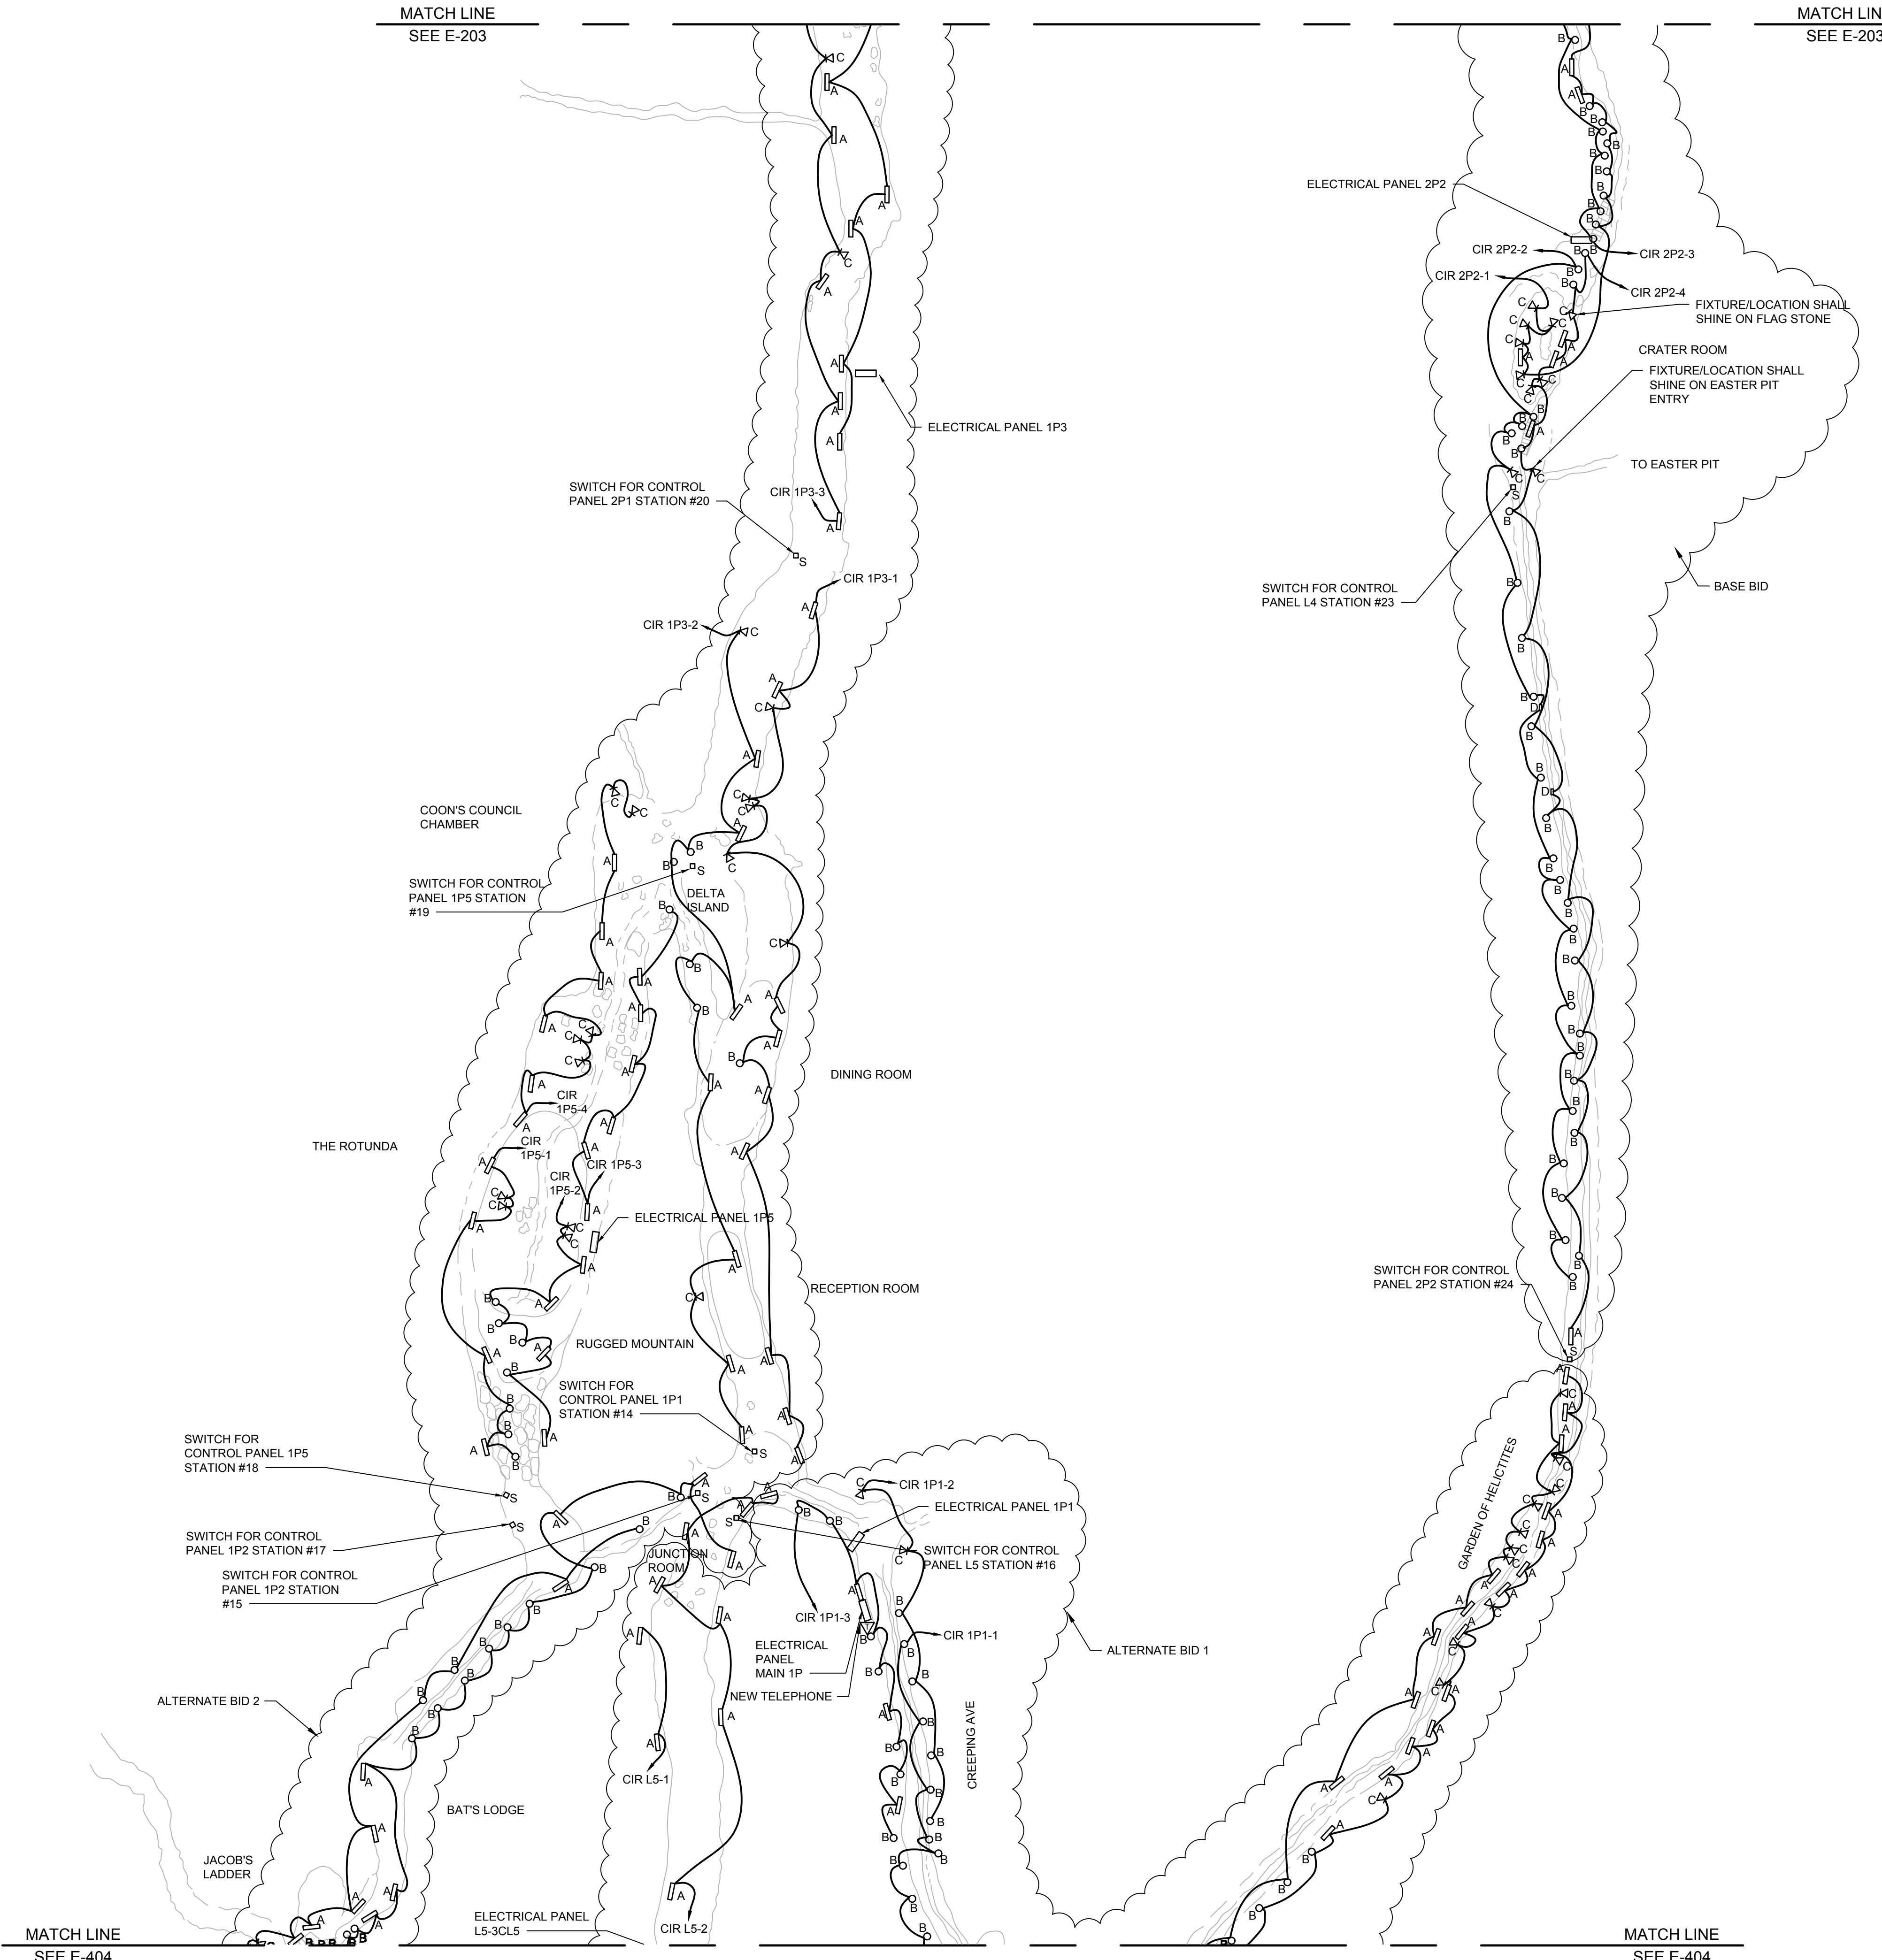

MATCH LINE
SEE E-404


MATCH LINE
SEE E-404

WYANDOTTE CAVE

SCALE: 1"=20'-0" 0 20' 40'



GRW PROJECT NO. 4495-25
 CLIENT PROJECT NO. XXXX
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**WYANDOTTE CAVE -
 MIDDLE OF CAVE NEW LIGHTING
 WYANDOTTE CAVE (LARGE)
 LEAVENWORTH, INDIANA**

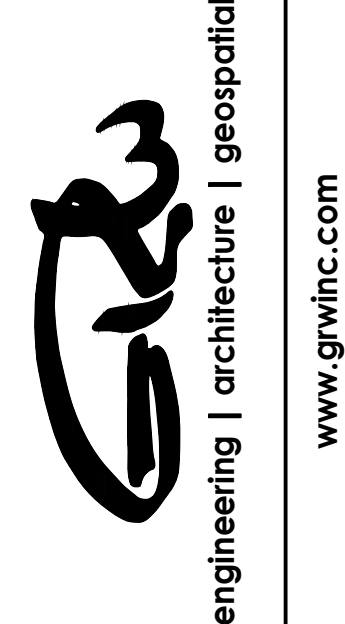DESIGNED	DRC
DRAWN	RHR
REVIEWED	WLM
APPROVED	WLM

NO.	REVISIONS	DATE	BY

DATE: SEPTEMBER 2018

SCALE: 1"=20'

SHEET NO.

E-405


BID DOCUMENTS

SYMBOLS:

- ▭ STRIP FLUORESCENT FIXTURE
- FLOOD LIGHT
- △ AIMABLE FLOOD LIGHT
- LIGHT SWITCH
- ▭ LIGHTING CONTROL PANEL L-1, L-2, OR L-3
- RUN OF 12-2 W/ GROUND COPPER GRAY JACKETED UF CABLE (TYPICAL)

GENERAL NOTE:


1. ALL A, B, AND C DESIGNATED LIGHT FIXTURES ON THIS DRAWING ARE NEW TO BE INSTALLED THIS CONTRACT.
2. ALL NEW ELECTRICAL LIGHTING WIRING SHALL BE 2#12, 1#12 GND JACKETED UF CABLE.
3. ALL NEW TELEPHONES SHALL BE GAL-TRONICS IN NEMA 4X ENCLOSURES. ALL TELEPHONES SHALL BE MOUNTED TO UNISTRUT AT LOCATIONS SHOWN IN THE SHEETS.
4. FEEDERS BETWEEN PANELS SHOWN ON SHEET E-409.
5. ALL NEW WIRING FOR SWITCHES/BUSHBUTTONS SHALL MATCH EXISTING WIRING USING NEW UF CABLE.
6. ALL ELECTRICAL PANELS ARE EXISTING.

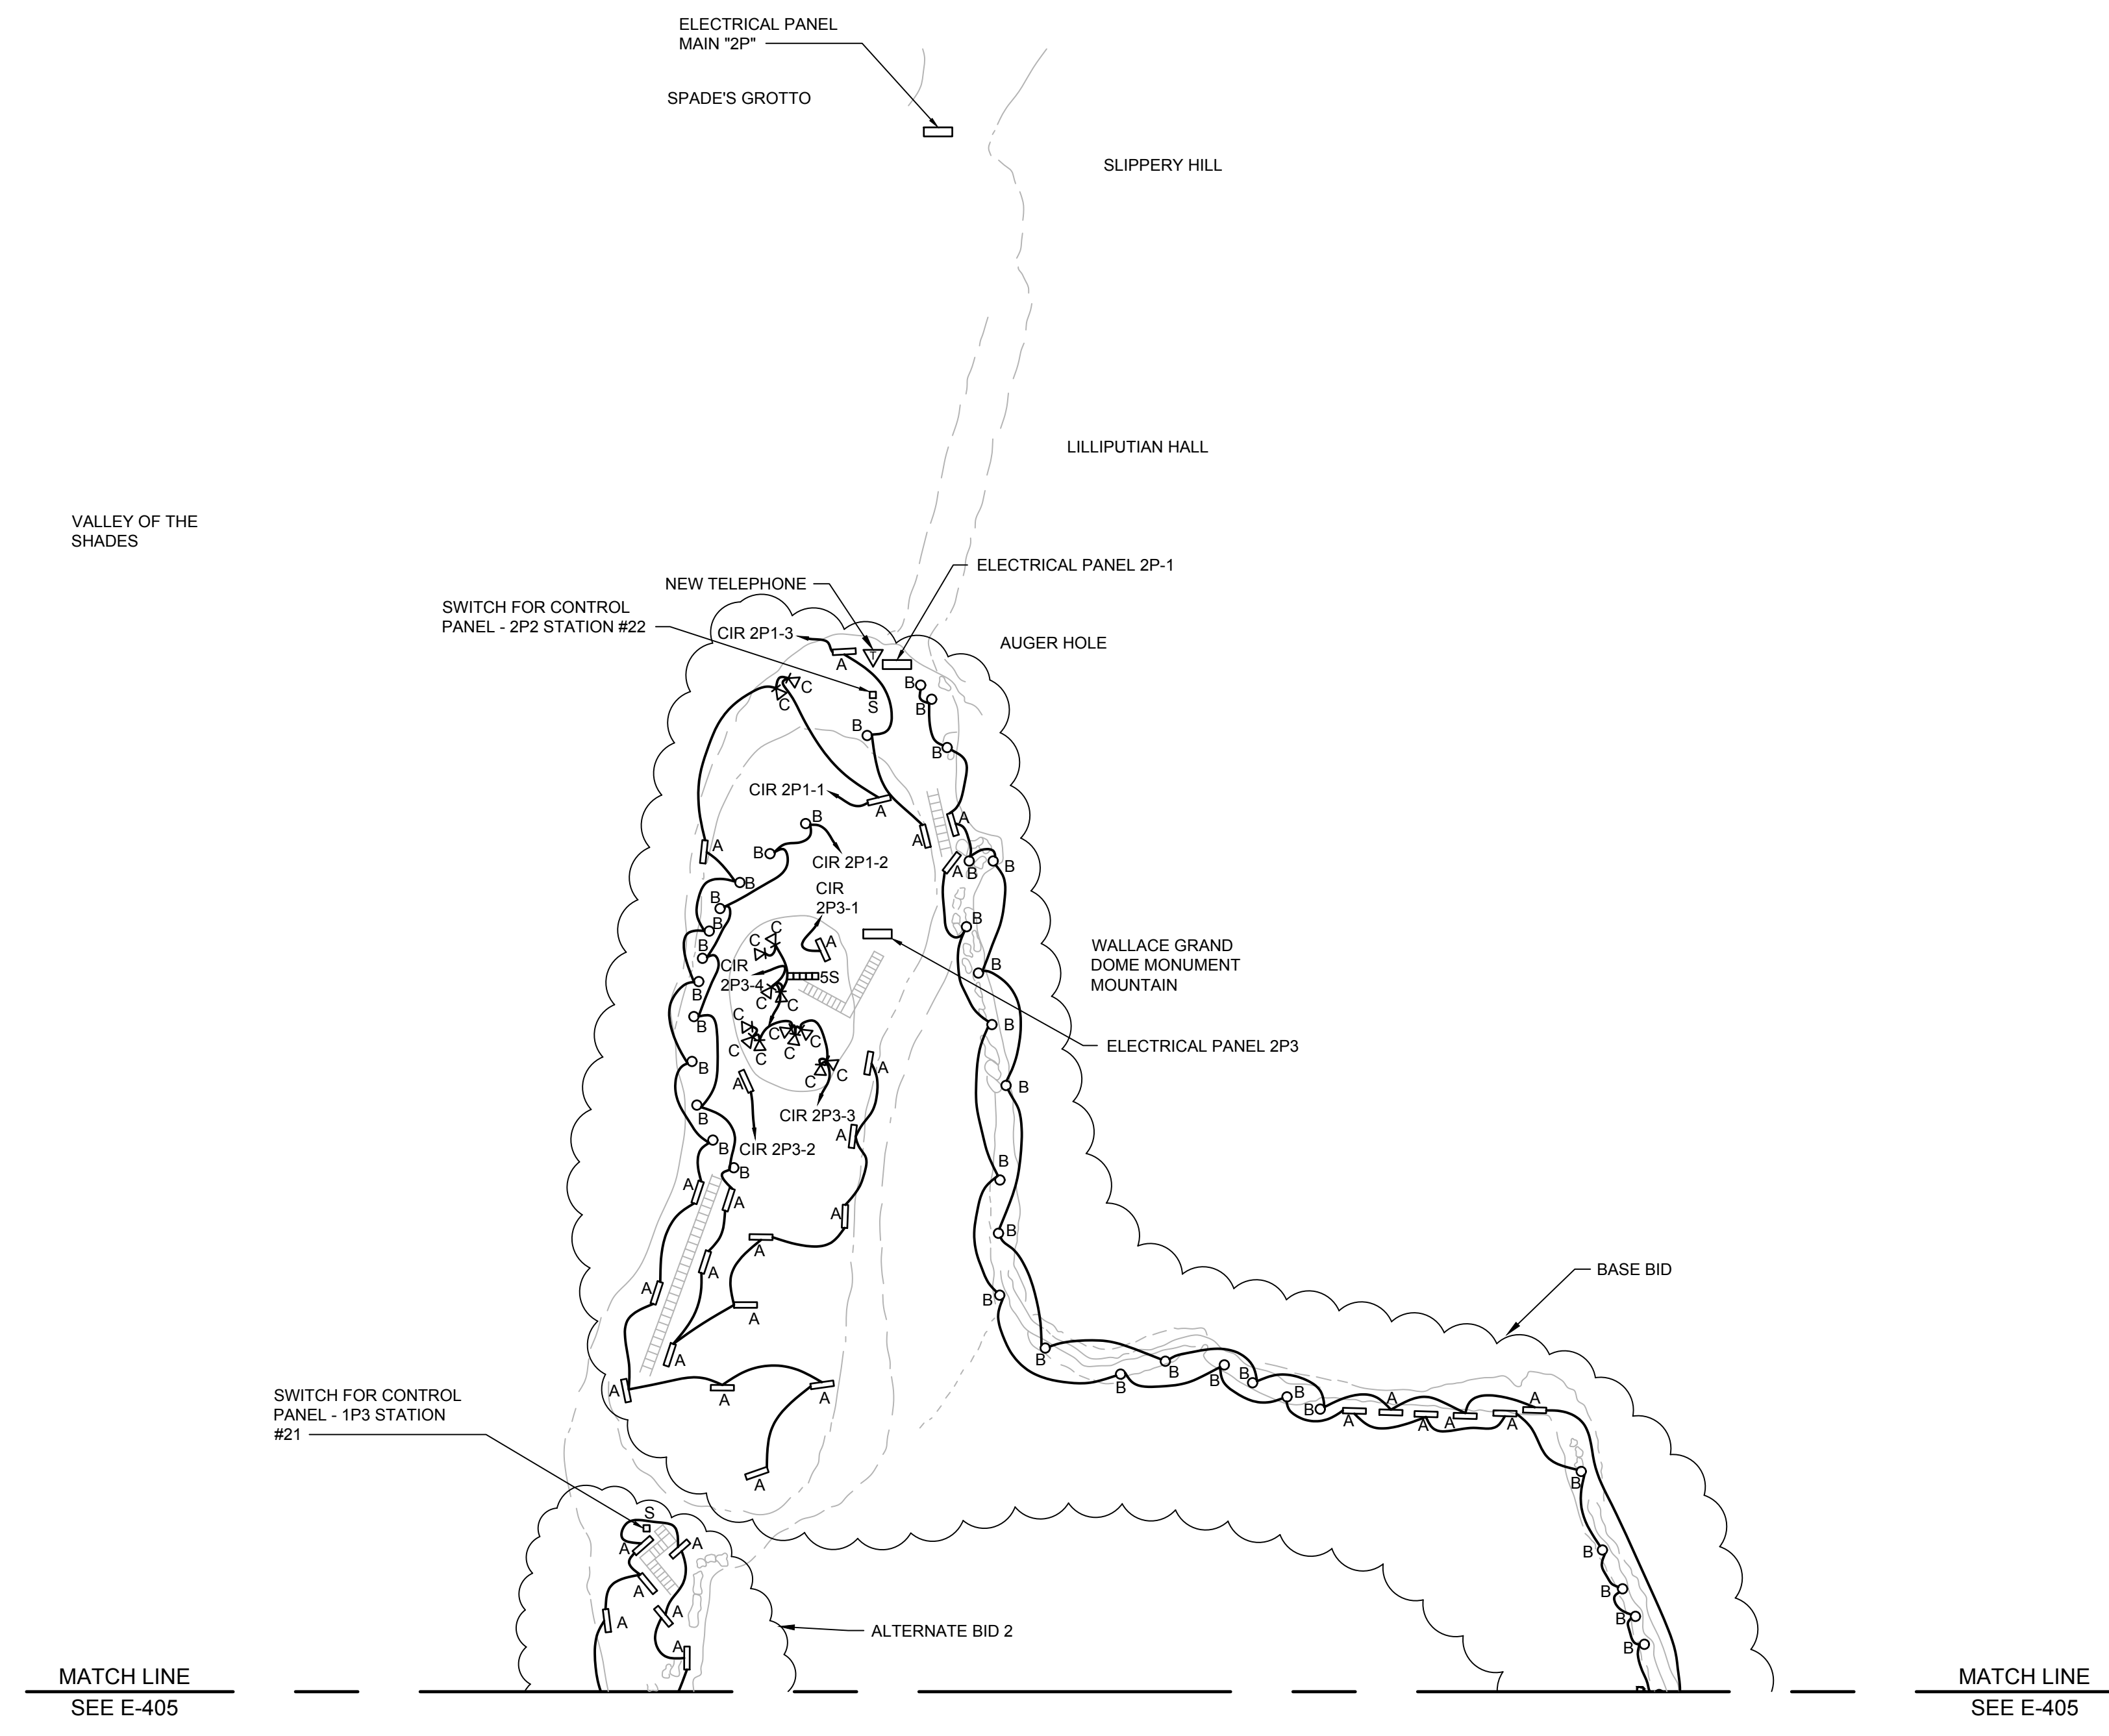

WYANDOTTE CAVE
 SCALE: 1"=20'-0" 0 20' 40'



GRW PROJECT NO. 4495-25
 CLIENT PROJECT NO. XXXX
 ALL RIGHTS RESERVED. NO PART OF THIS DOCUMENT SHALL BE REPRODUCED IN WHOLE OR IN PART WITHOUT WRITTEN PERMISSION.

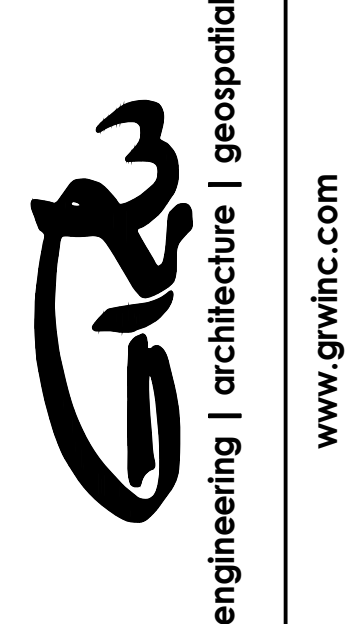

**WYANDOTTE CAVE
 END OF CAVE NEW LIGHTING
 WYANDOTTE CAVE (LARGE)
 LEAVENWORTH, INDIANA**

DESIGNED	DRC
DRAWN	RHR
REVIEWED	WLM
APPROVED	WLM

NO.	DATE	DESCRIPTION

SCALE CHECK: _____ THIS MARK SHOULD MEASURE EXACTLY 1" WHEN PLOTTED


DATE: SEPTEMBER 2018
 SCALE: 1"=20'
 SHEET NO.

E-406

PLOTTED BY: bramsey

PRINTED: 9/26/2018 @ 8:59AM

FILE NAME: G:\485\INR-Bat Cave\Working Drawings\AutoCAD\Large Cave\4495-E-407.dwg

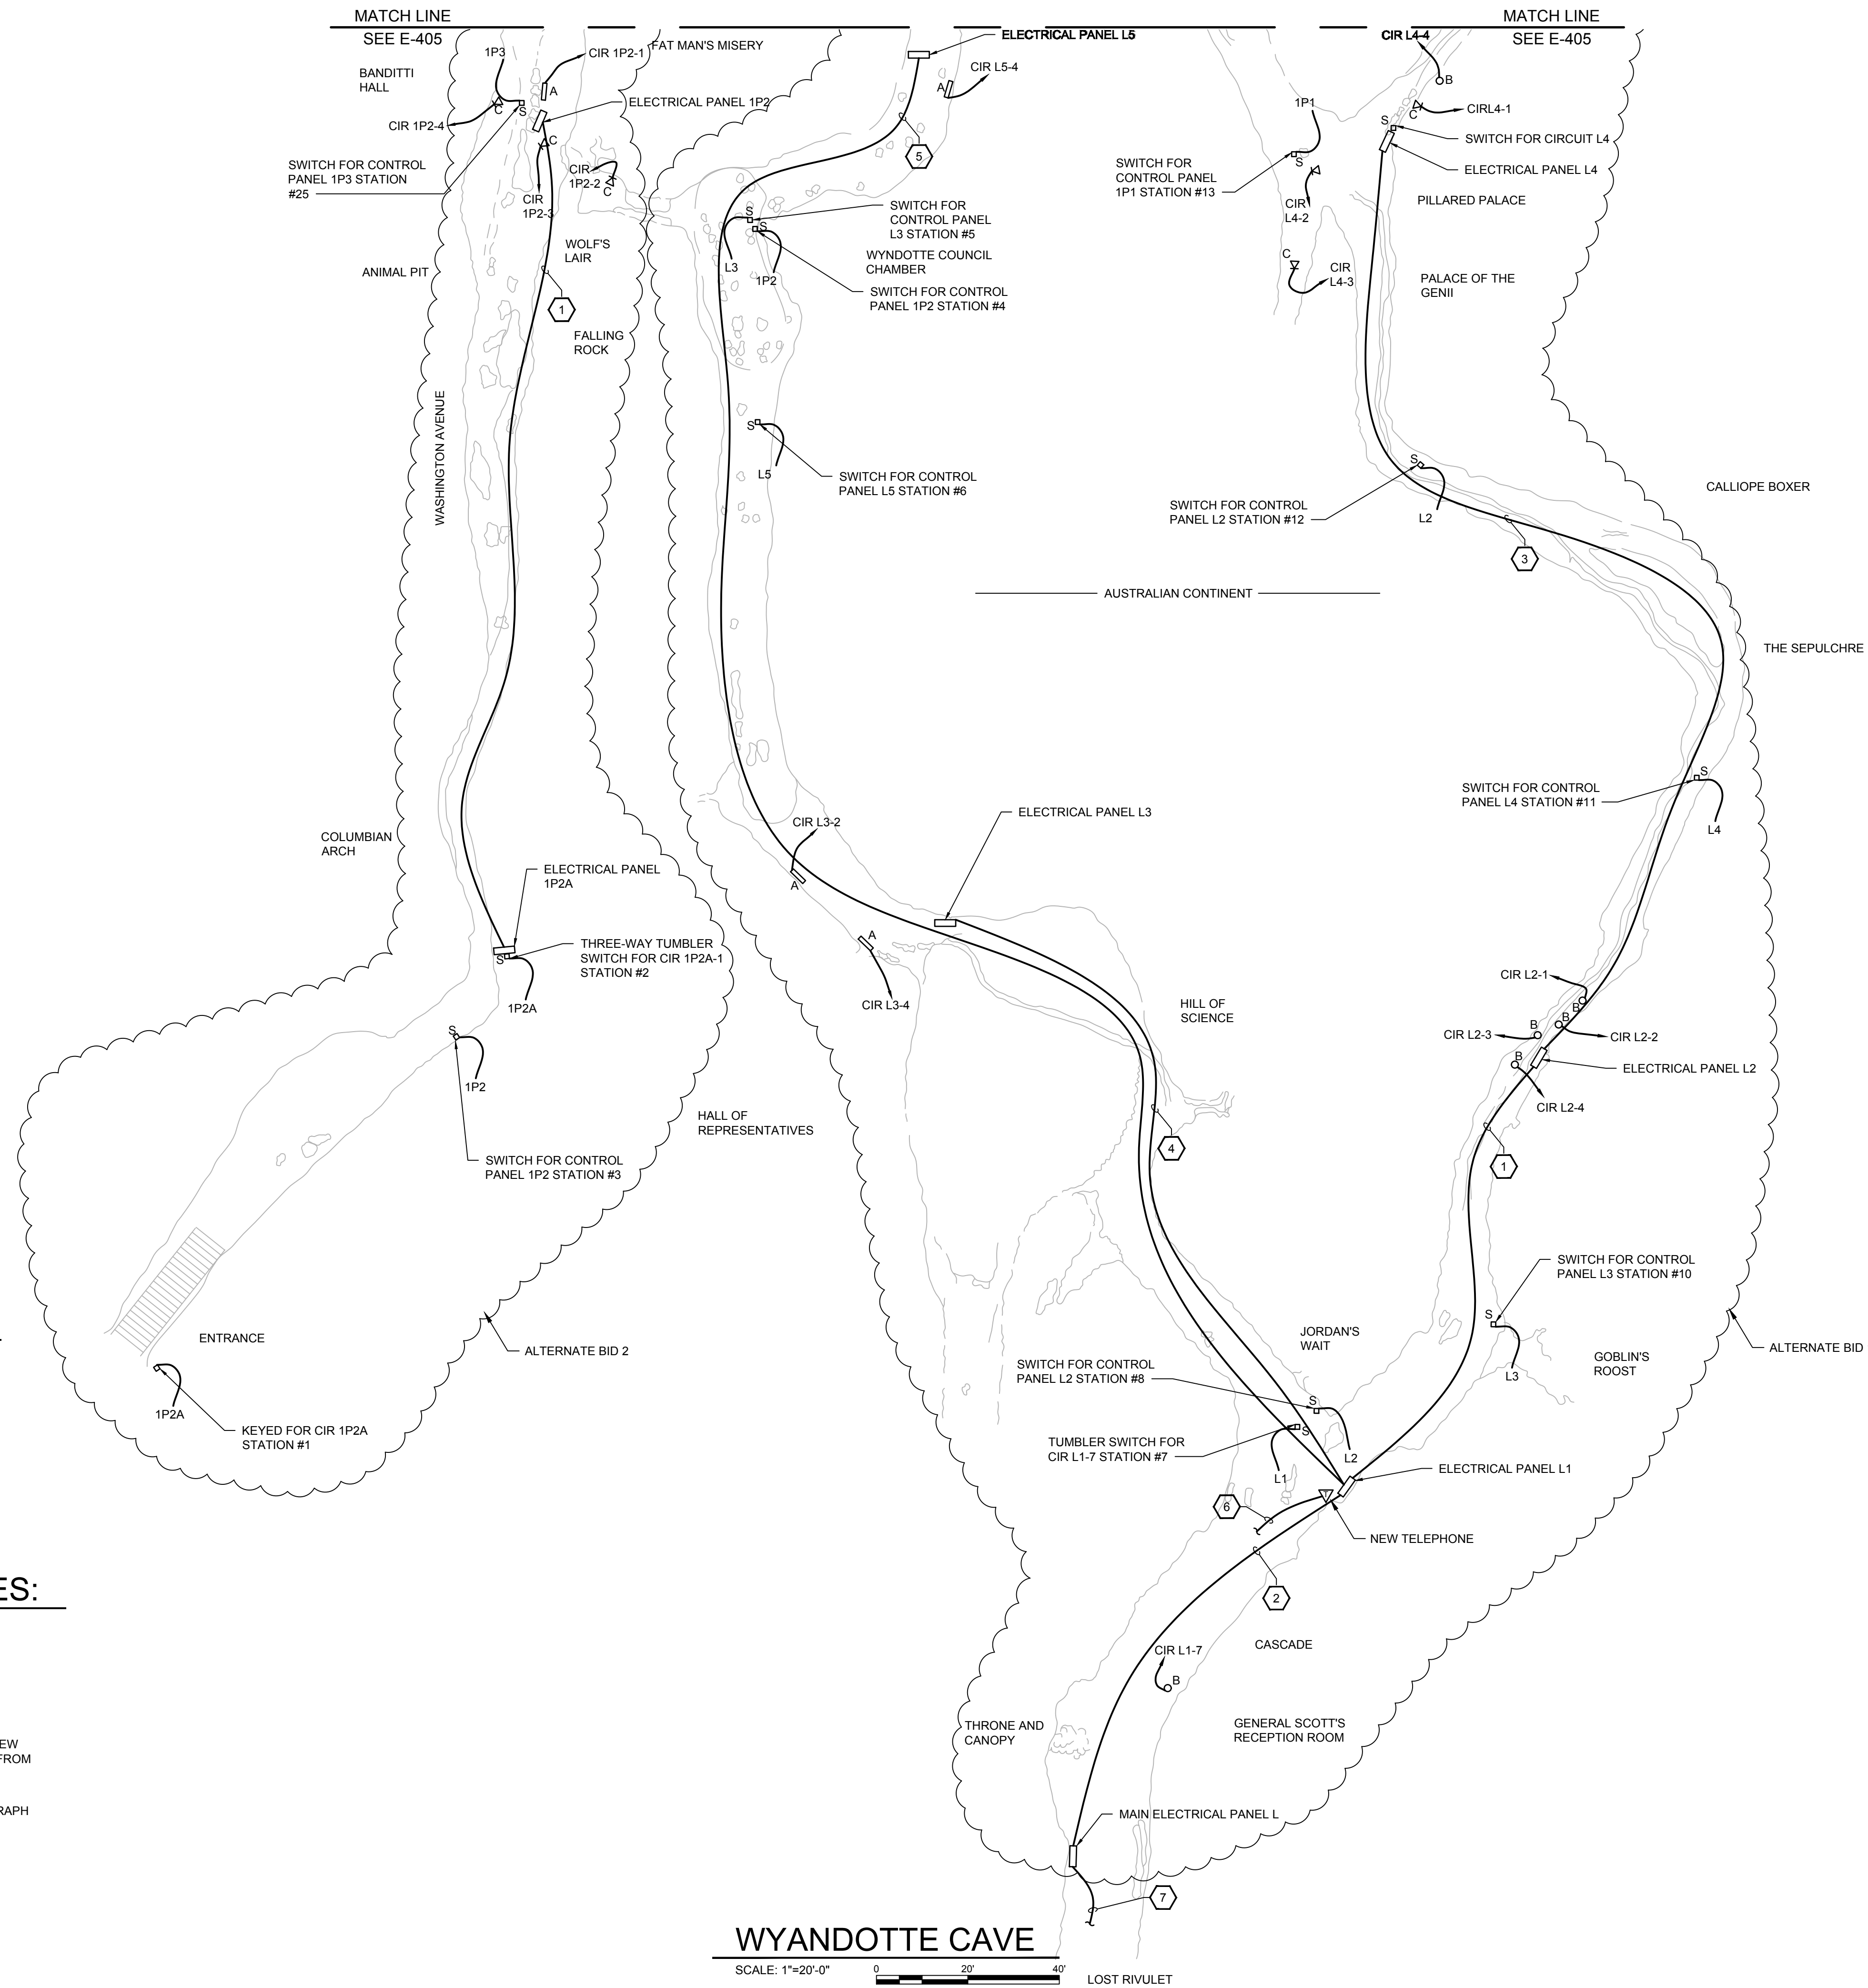

SYMBOLS:

- 1x8 LED LIGHT
- LED FLOOD LIGHT
- LED AIMABLE FLOOD LIGHT
- LED POLE LIGHT
- LIGHT SWITCH
- LIGHTING CONTROL PANEL
- RUN OF 12-2 W/ GROUND COPPER GRAY JACKETED UF CABLE (TYPICAL)

GENERAL NOTE:

1. ALL A, B, C, AND E DESIGNATED LIGHT FIXTURES ON THIS DRAWING ARE NEW TO BE INSTALLED THIS CONTRACT.
2. ALL NEW ELECTRICAL LIGHTING WIRING SHALL BE 2#12, 1#12 GND JACKETED UF CABLE.
3. ALL NEW TELEPHONES SHALL BE GAL-TRONICS IN NEMA 4X ENCLOSURES. ALL TELEPHONES SHALL BE MOUNTED TO UNISTRUT AT LOCATIONS SHOWN IN THE SHEETS.

SHEET KEYNOTES:


1. EXISTING 3#6, 1#10 GND, 1" PVC.
2. EXISTING 3#3/0, 1#6 GND, 2" PVC.
3. EXISTING 3#1, 1#10 GND, 1 1/2" PVC.
4. EXISTING 3#6, 1#10 GND, 1" PVC.
5. EXISTING 3#4, 1#10 GND, 1" PVC.
6. NEW CAT 6 INTERLOCK ARMORED CABLE TO NEW GAL-TRONICS NEMA 4X RUGGED TELEPHONE FROM NEW TELEPHONE ACCESS POINT LOCATED IN SEISMOGRAPH BUILDING.
7. TO SERVICE DROP LOCATED IN THE SEISMOGRAPH BUILDING.

WYANDOTTE CAVE

SCALE: 1"=20'-0" 0 20' 40'



GRW PROJECT NO. 4495-25
 CLIENT PROJECT NO. XXXX
 ALL RIGHTS RESERVED. THIS DOCUMENT IS THE PROPERTY OF GRW ENGINEERS, P.C. AND SHALL NOT BE REPRODUCED IN WHOLE OR IN PART WITHOUT WRITTEN PERMISSION.

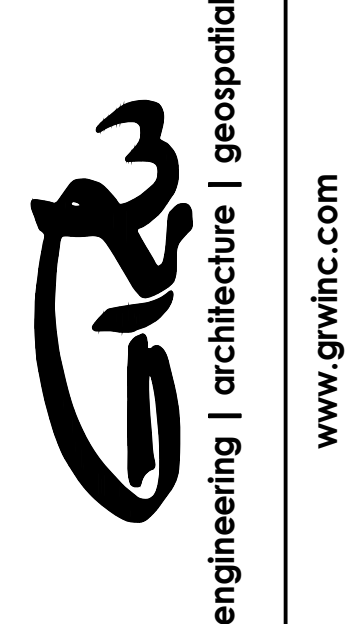

**WYANDOTTE CAVE -
 ENTRANCE OF CAVE NEW POWER
 WYANDOTTE CAVE (LARGE)
 LEAVENWORTH, INDIANA**

DESIGNED	DRC	DRAWN	RHR	REVIEWED	WLM	APPROVED	WLM
----------	-----	-------	-----	----------	-----	----------	-----

NO.	REVISIONS	DESCRIPTION	DATE	BY

DATE: SEPTEMBER 2018
 SCALE: 1"=20'
 SHEET NO.

E-407

BID DOCUMENTS

MATCH LINE
SEE E-409

MATCH LINE
SEE E-409



GRW PROJECT NO. 4485-25
CLIENT PROJECT NO. XXXX
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WYANDOTTE CAVE - MIDDLE OF CAVE NEW POWER WYANDOTTE CAVE (LARGE) LEAVENWORTH, INDIANA

DESIGNED	DRC
DRAWN	RHR
REVIEWED	WLM
APPROVED	WLM

NO.	DATE	DESCRIPTION

DATE: SEPTEMBER 2018
SCALE: 1"=20'
SHEET NO.

E-408

BID DOCUMENTS

PLOTTED BY: bramsey

PRINTED: 9/26/2018 @ 8:59AM

FILE NAME: G:\485-IDNR-Bat Cave\Working Drawings\AutoCAD\Large Cave\4485-E-408.dwg

SYMBOLS:


- 1X8 LED LIGHT
- LED FLOOD LIGHT
- LED AIMABLE FLOOD LIGHT
- LED STEP LIGHT
- LIGHT SWITCH
- LIGHTING CONTROL PANEL
- RUN OF 12-2 W/ GROUND COPPER GRAY JACKETED UF CABLE (TYPICAL)

GENERAL NOTE:

- ALL A, B, C, AND D DESIGNATED LIGHT FIXTURES ON THIS DRAWING ARE NEW TO BE INSTALLED THIS CONTRACT.
- ALL NEW ELECTRICAL LIGHTING WIRING SHALL BE #12, 1#12 GND JACKETED UF CABLE.
- ALL NEW TELEPHONES SHALL BE GAI-TRONICS IN NEMA 4X ENCLOSURES. ALL TELEPHONES SHALL BE MOUNTED TO UNISTRUT AT LOCATIONS SHOWN IN THE SHEETS.

SHEET KEYNOTES:

- NEW CAT 6 INTERLOCK ARMORED CABLE TO NEW GAI-TRONICS NEMA 4X RUGGED TELEPHONE FROM NEW TELEPHONE ACCESS POINT LOCATED AT ALTERNATE 2 SERVICE DROP.
- 3#4, 1#6 GND, 1 1/4" SCHEDULE 80 PVC
- 3#1, 1#10 GND, 1 1/2" SCHEDULE 80 PVC

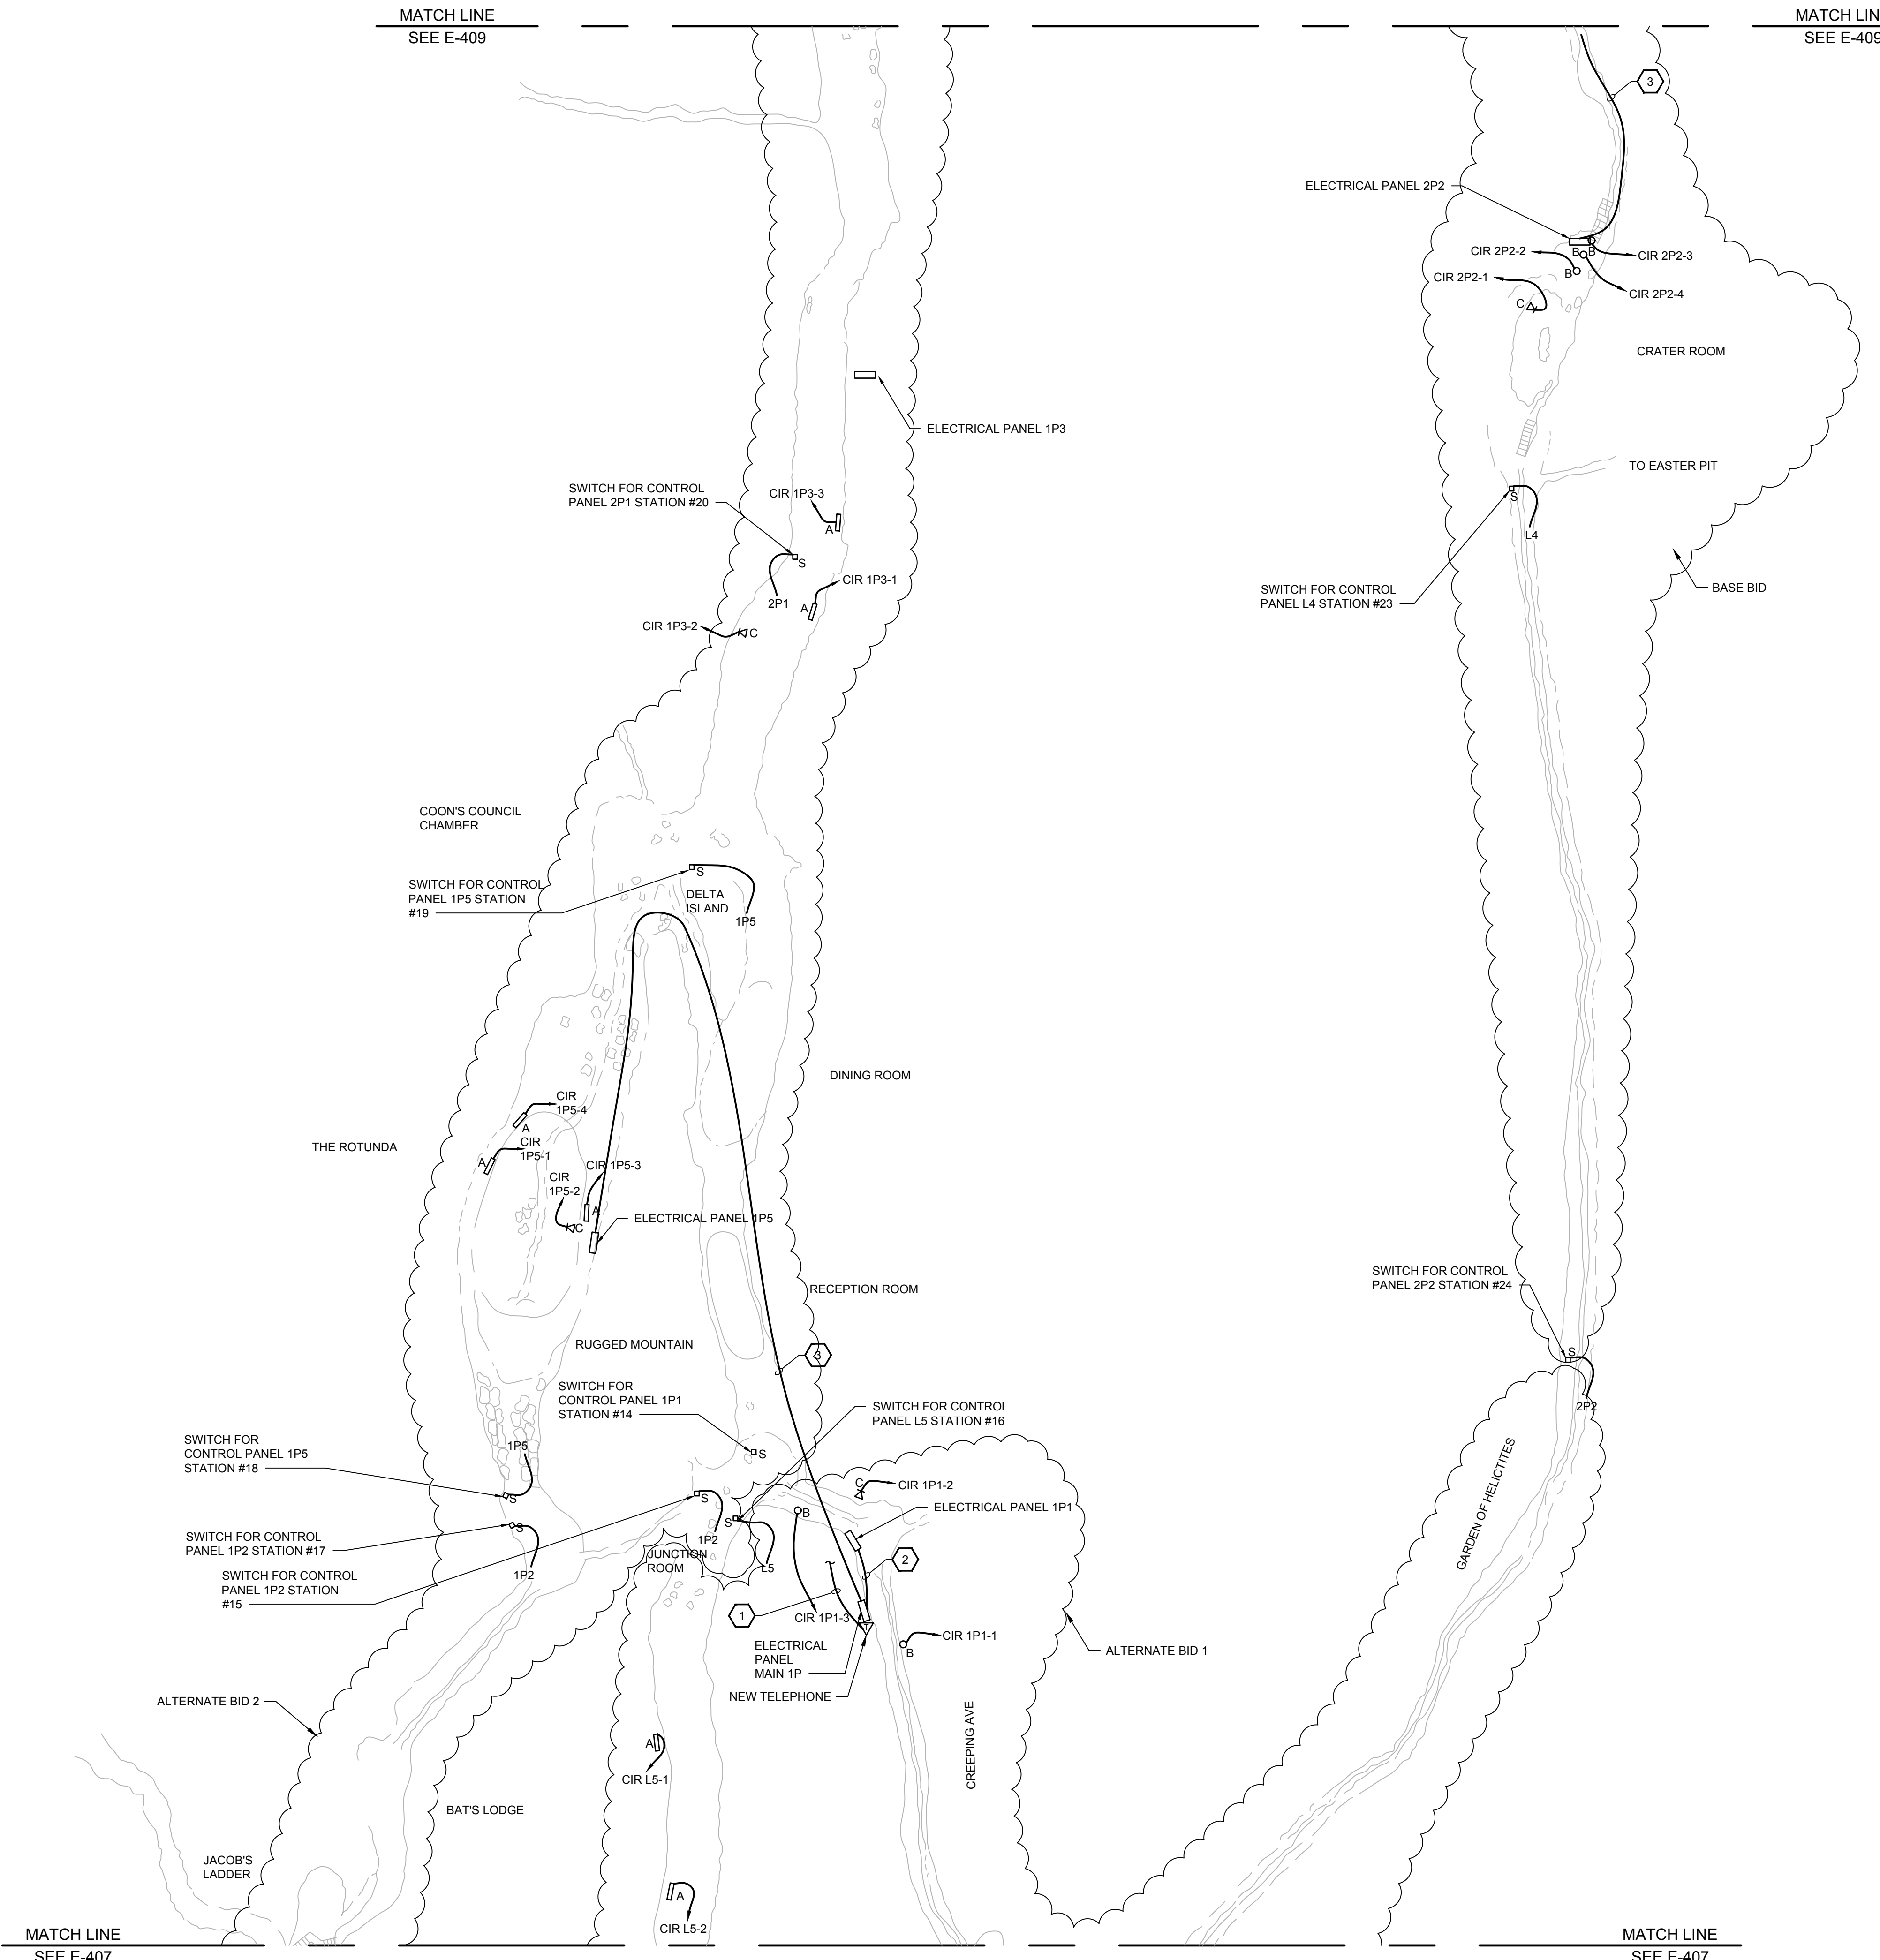

WYANDOTTE CAVE

SCALE: 1"=20'-0" 0 20' 40'

SYMBOLS:


- ▭ STRIP FLUORESCENT FIXTURE
- FLOOD LIGHT
- △ AIMABLE FLOOD LIGHT
- LIGHT SWITCH
- ▭ LIGHTING CONTROL PANEL L-1, L-2, OR L-3
- RUN OF 12-2 W/ GROUND COPPER GRAY JACKETED UF CABLE (TYPICAL)

GENERAL NOTE:

1. ALL A, B, AND C DESIGNATED LIGHT FIXTURES ON THIS DRAWING ARE NEW TO BE INSTALLED THIS CONTRACT.
2. ALL NEW ELECTRICAL LIGHTING WIRING SHALL BE 2#12, 1#12 GND JACKETED UF CABLE.
3. ALL NEW TELEPHONES SHALL BE GAL-TRONICS IN NEMA 4X ENCLOSURES. ALL TELEPHONES SHALL BE MOUNTED TO UNISTRUT AT LOCATIONS SHOWN IN THE SHEETS.

SHEET KEYNOTES:

1. 3#6, 1#10 1" SCHEDULE 80 PVC
2. 3#10, 1#10 GND 3/4" SCHEDULE 80 PVC
3. NEW CAT 6 INTERLOCK ARMORED CABLE TO NEW GAL-TRONICS NEMA 4X RUGGED TELEPHONE FROM NEW TELEPHONE ACCESS POINT LOCATED AT BASE BID SERVICE DROP.

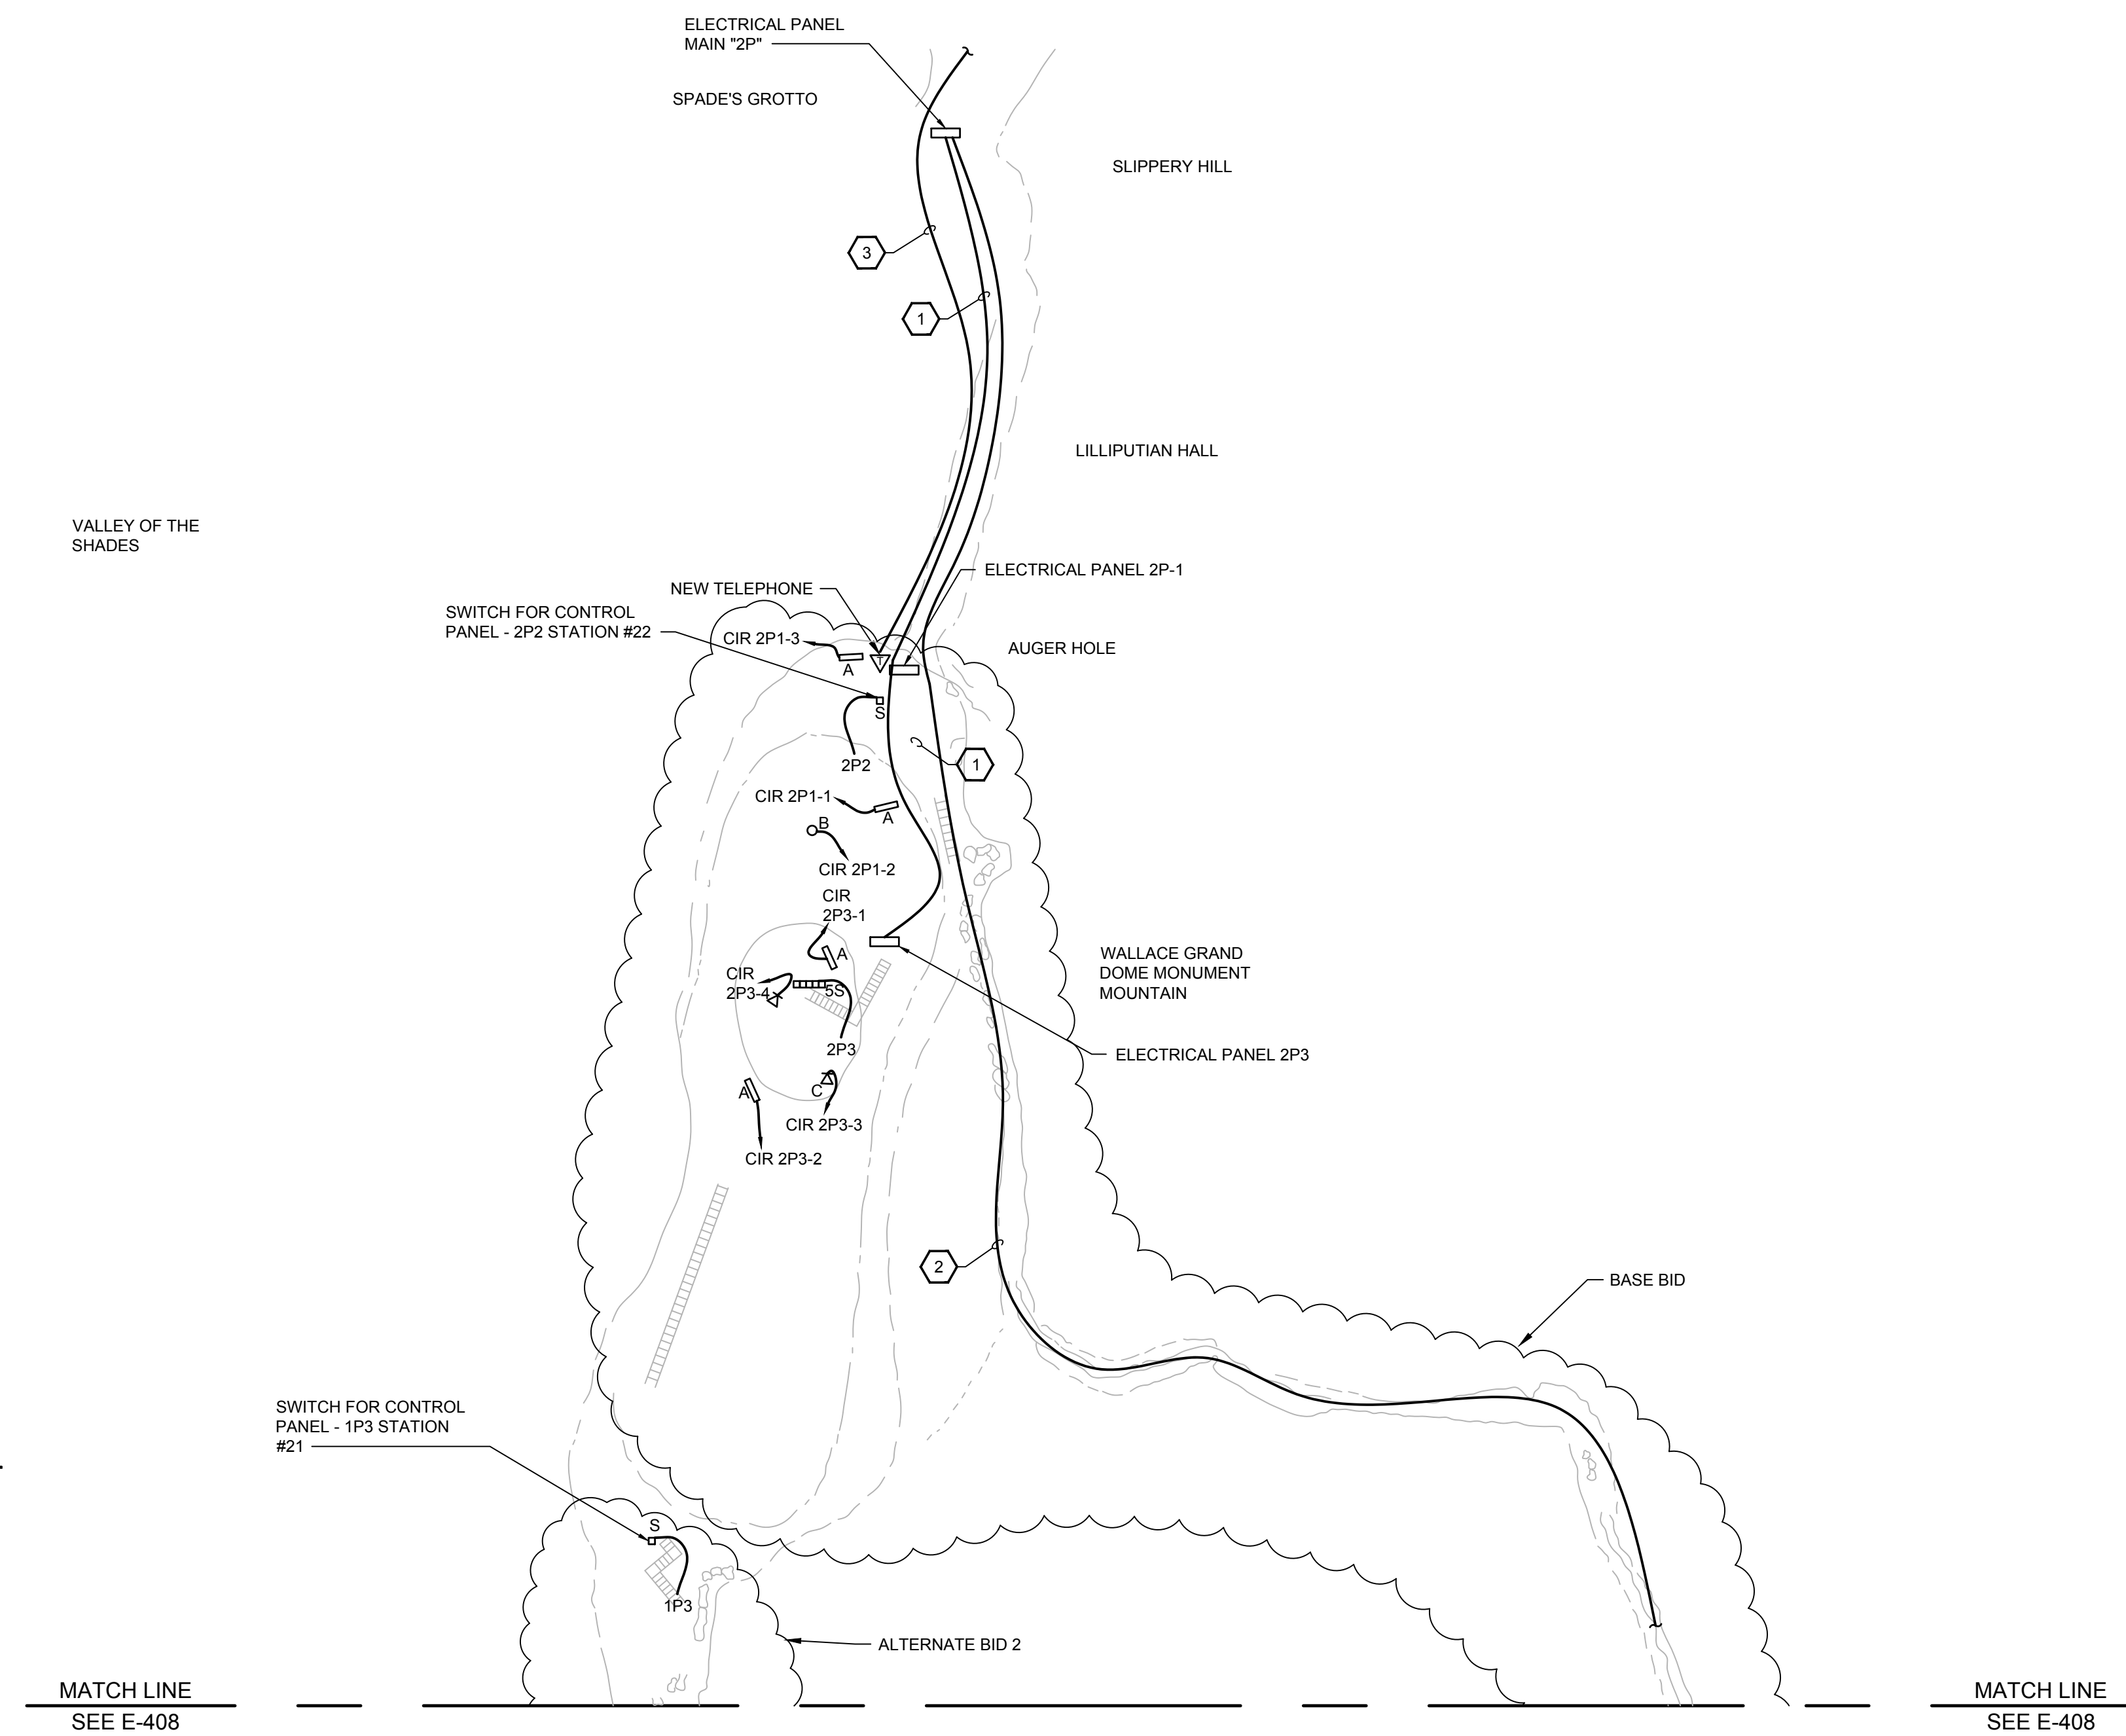


WYANDOTTE CAVE

SCALE: 1"=20'-0" 0 20' 40'



GRW PROJECT NO. 4485-25
 CLIENT PROJECT NO. XXXX
 ALL RIGHTS RESERVED. NO PART OF THIS DOCUMENT SHALL BE REPRODUCED IN WHOLE OR IN PART WITHOUT THE WRITTEN PERMISSION OF GRW ENGINEERS, P.C. AND SHALL NOT BE USED FOR ANY OTHER PROJECT OTHER THAN THIS SPECIFIC PROJECT WITHOUT WRITTEN PERMISSION.

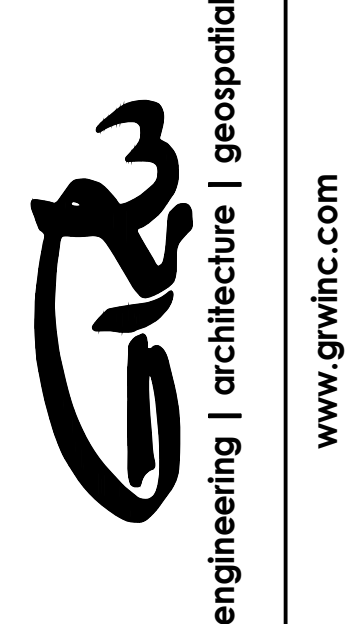

**WYANDOTTE CAVE
 END OF CAV NEW POWER
 WYANDOTTE CAVE (LARGE)
 LEAVENWORTH, INDIANA**


DESIGNED	DRC
DRAWN	RHR
REVIEWED	WLM
APPROVED	WLM

NO.	DATE	DESCRIPTION


SCALE CHECK: _____ THIS MARK SHOULD MEASURE EXACTLY 1" WHEN PLOTTED

DATE: SEPTEMBER 2018
 SCALE: 1"=20'
 SHEET NO.

E-409

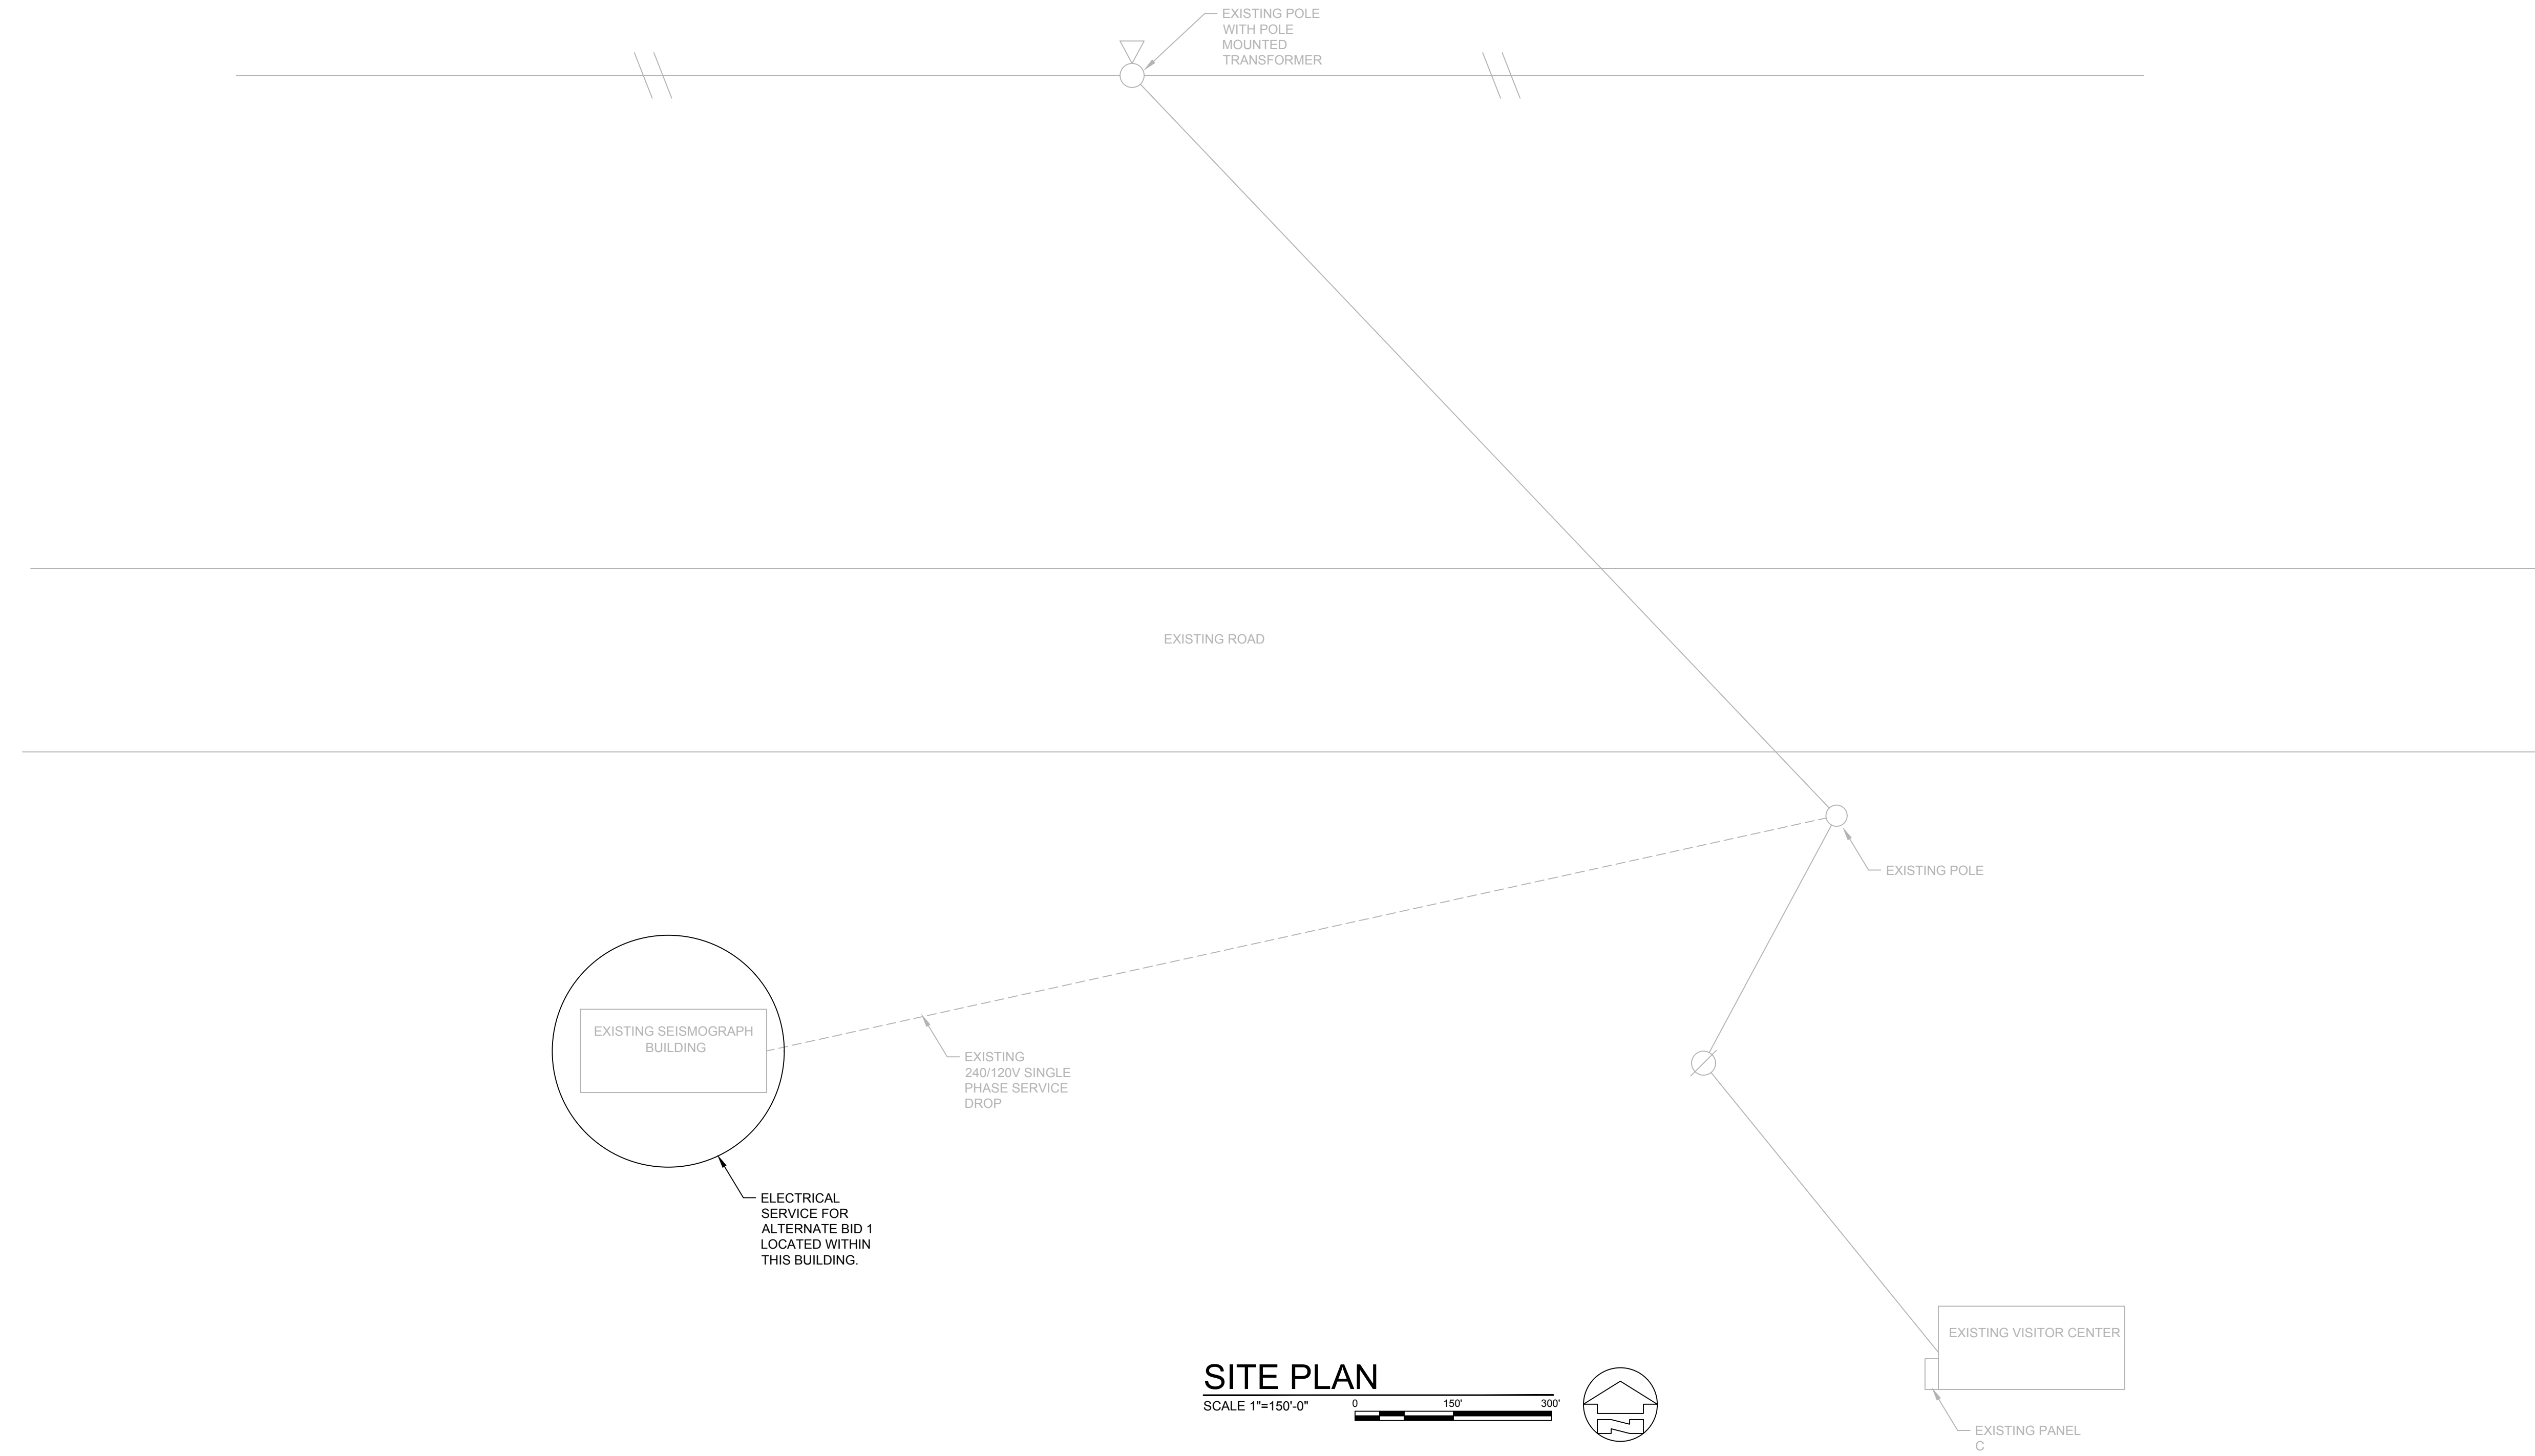

GRW PROJECT NO. 4495-25
 CLIENT PROJECT NO. XXXX
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WYANDOTTE CAVE VISITOR CENTER
 WYANDOTTE CAVE (LARGE)
 LEAVENWORTH, INDIANA

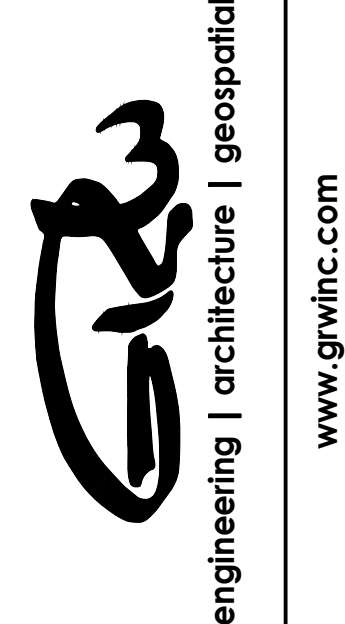
DESIGNED	DRC
DRAWN	RHR
REVIEWED	WLM
APPROVED	WLM

NO.	REVISIONS	DATE	BY
	DESCRIPTION		

SCALE CHECK: _____ THIS MARK SHOULD MEASURE EXACTLY 1" WHEN PLOTTED


DATE: SEPTEMBER 2018
 SCALE: NOT TO SCALE
 SHEET NO.

E-410

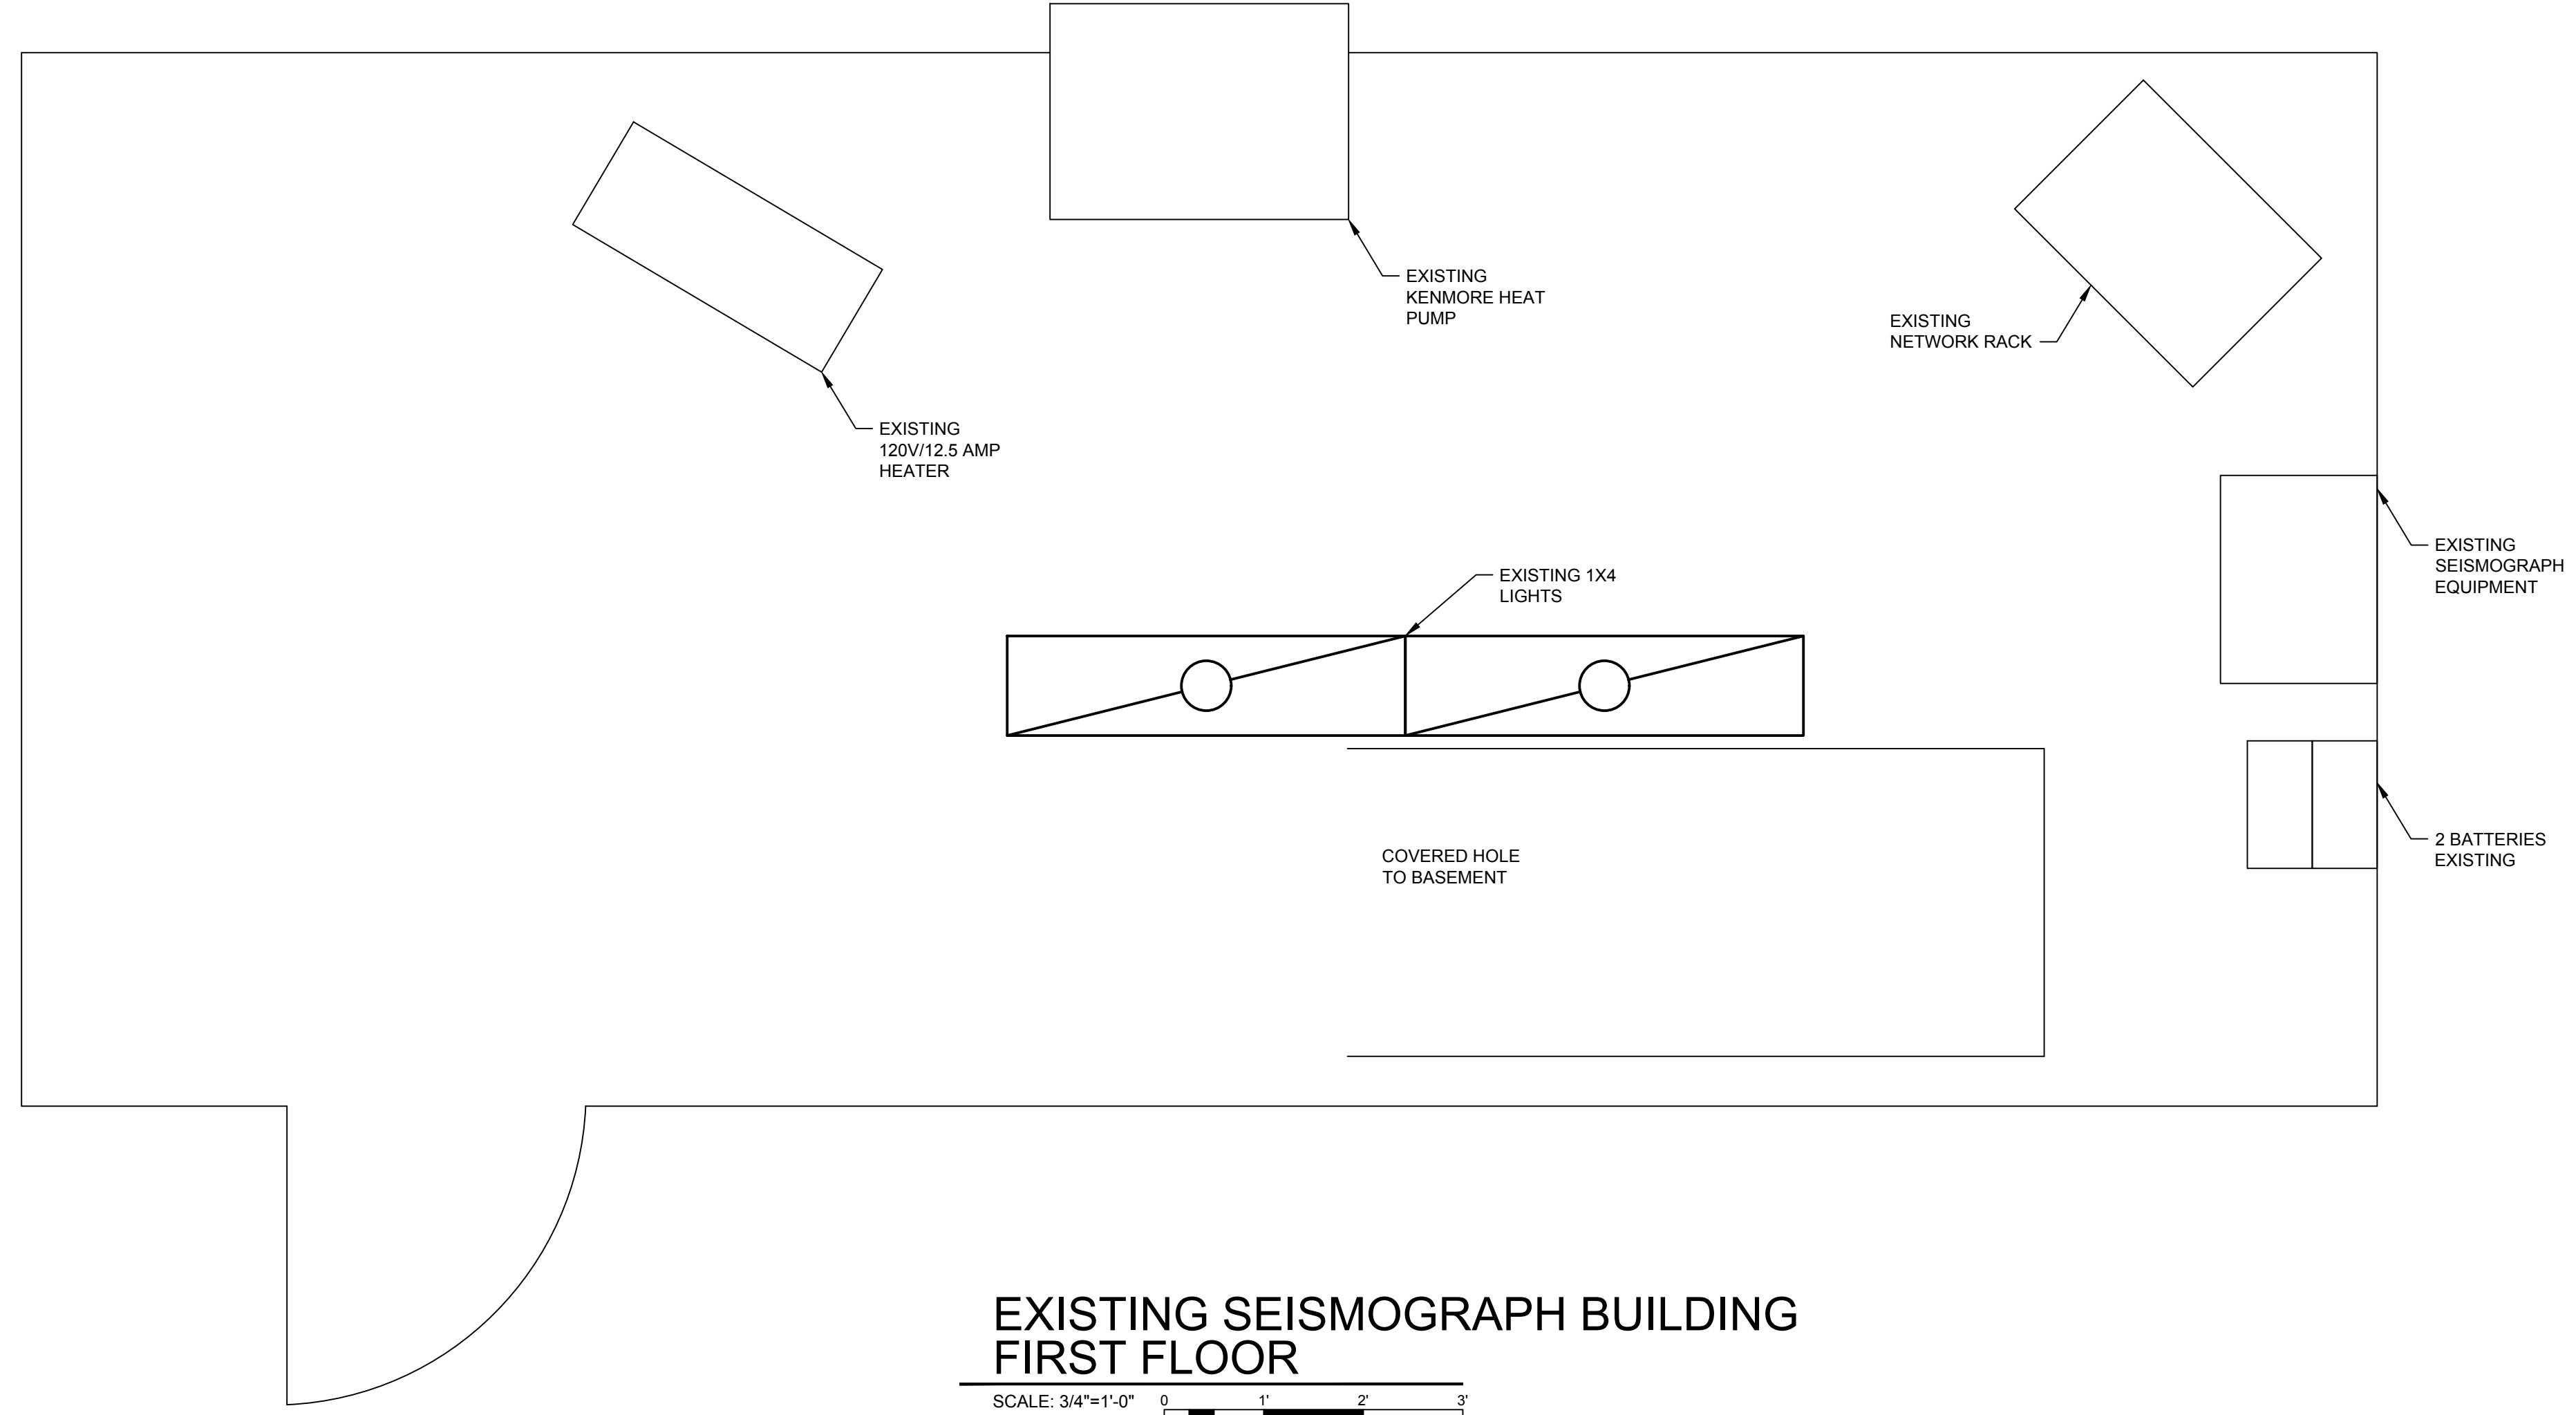

EXISTING SEISMOGRAPH BUILDING
FIRST FLOOR

SCALE: 3/4"=1'-0"

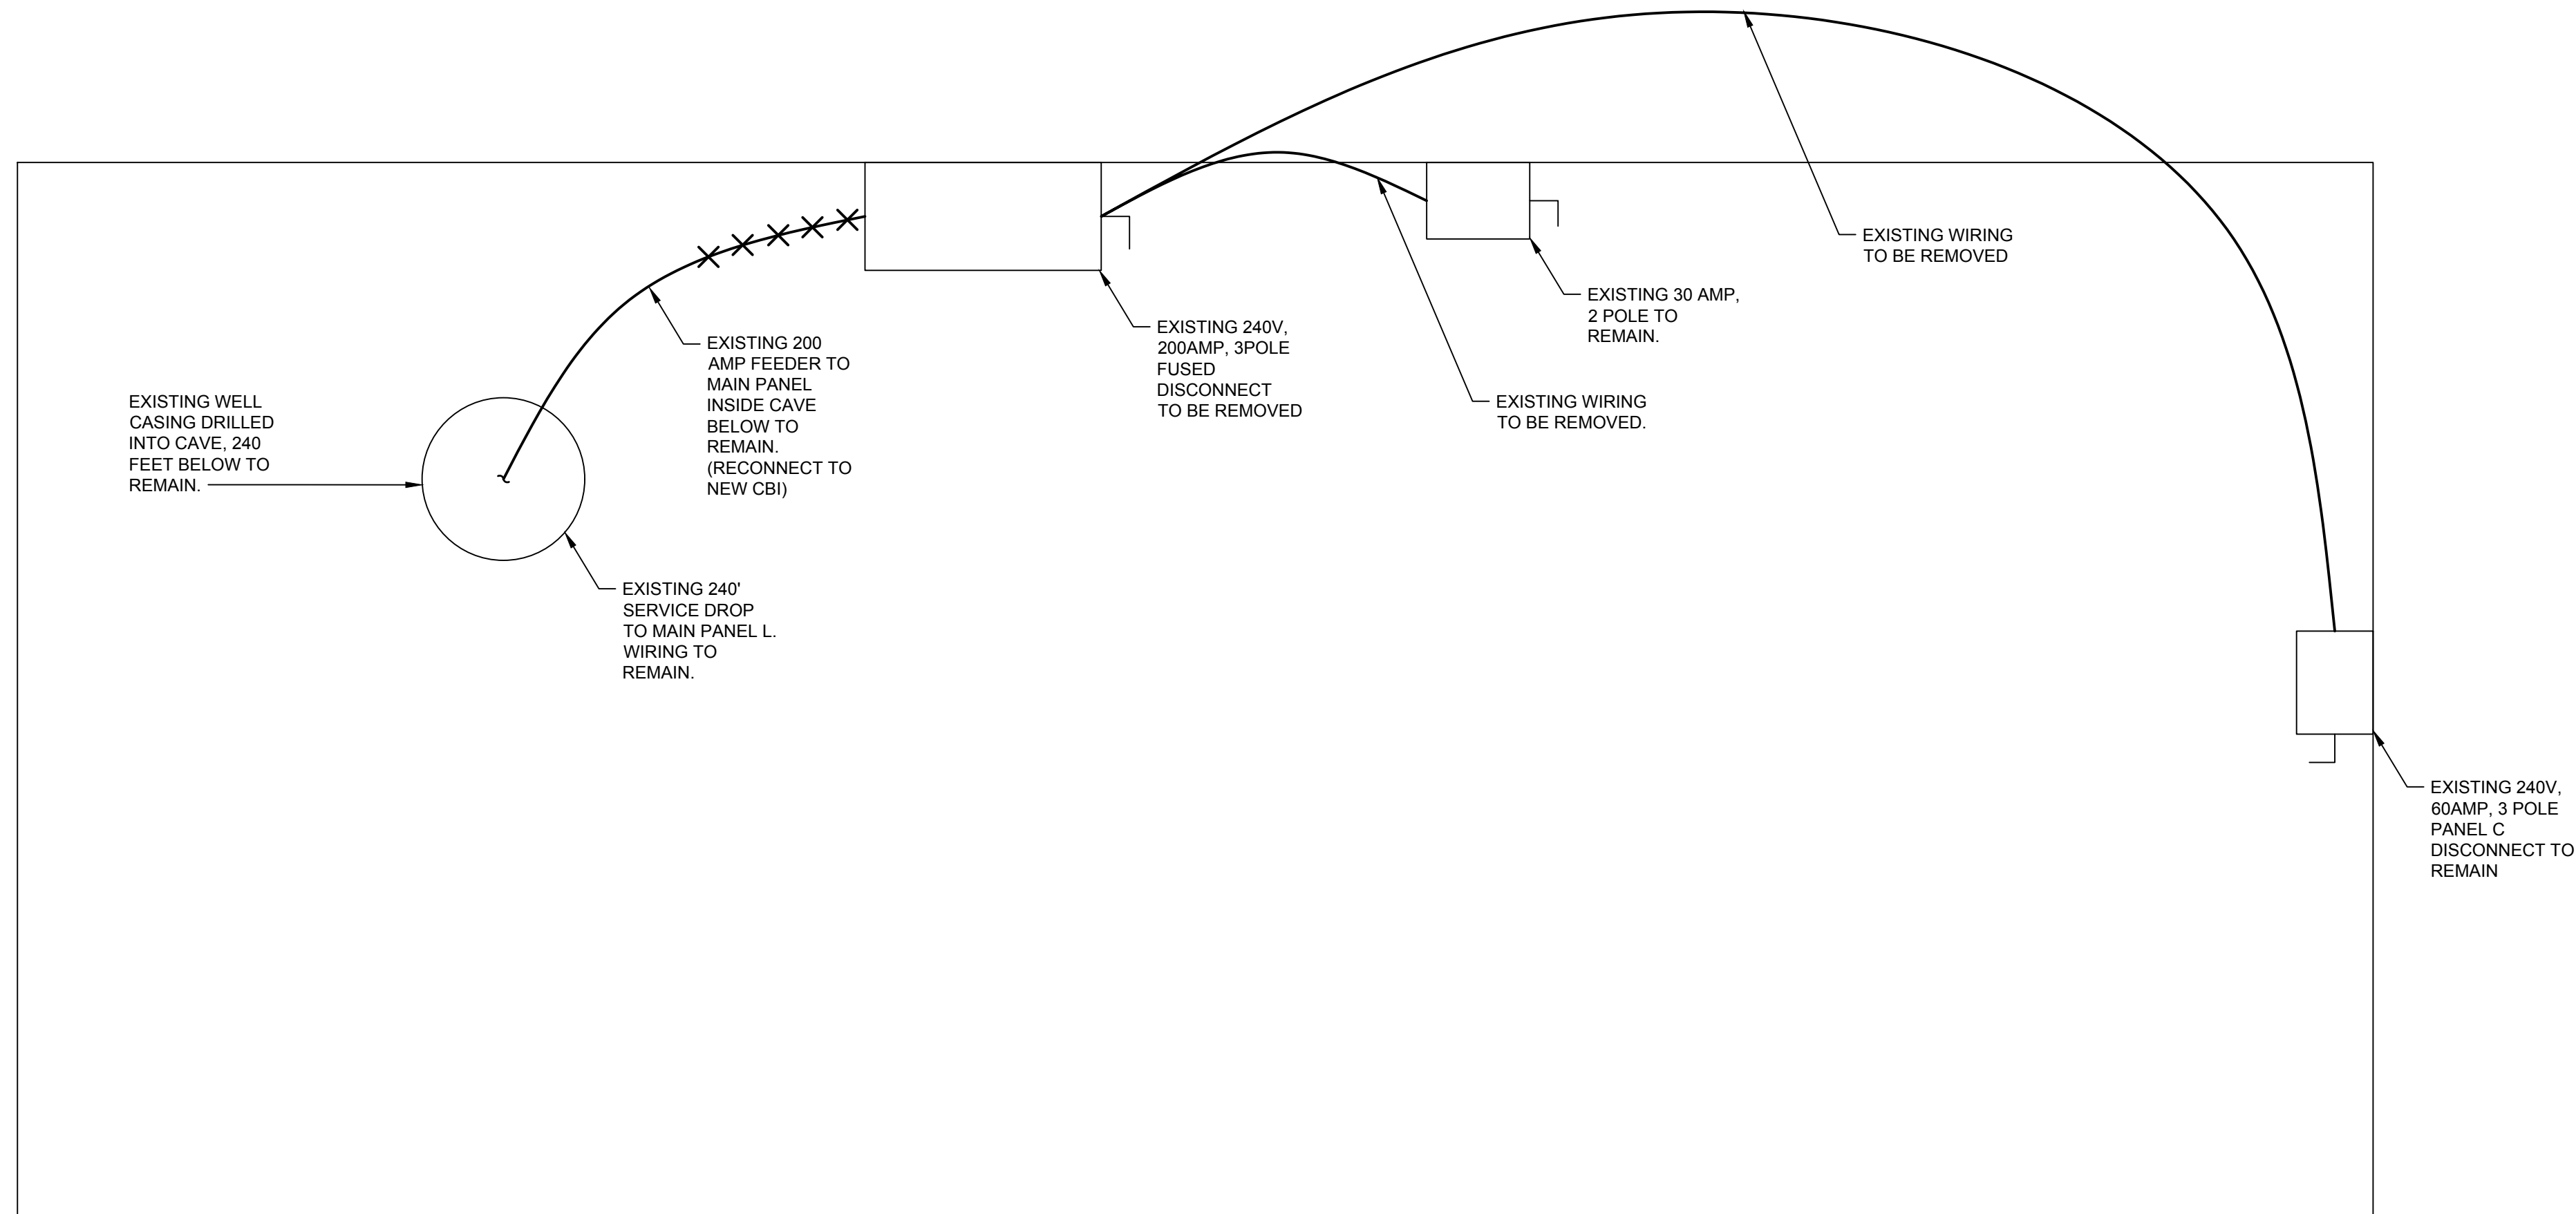


EXISTING SEISMOGRAPH BUILDING
BASEMENT

SCALE: 3/4"=1'-0"



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WYANDOTTE CAVE -
SEISMOGRAPH BUILDING DEMO
WYANDOTTE CAVE (LARGE)
LEAVENWORTH, INDIANA

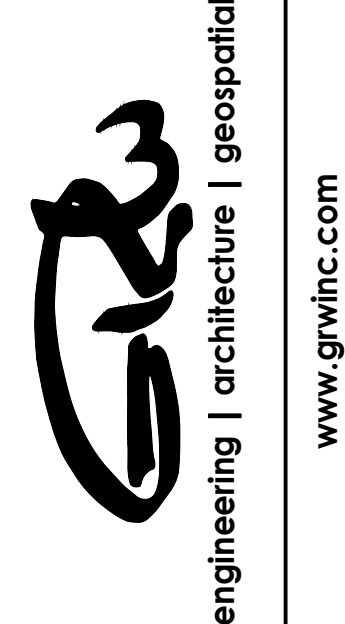DESIGNED	DRC
DRAWN	RHR
REVIEWED	WLM
APPROVED	WLM

NO.	REVISIONS	DATE	BY
	DESCRIPTION		

SCALE CHECK: _____ THIS MARK SHOULD MEASURE EXACTLY 1" WHEN PLOTTED


DATE: SEPTEMBER 2018
SCALE: NOT TO SCALE
SHEET NO.

E-411

PLOTTED BY: bramsey


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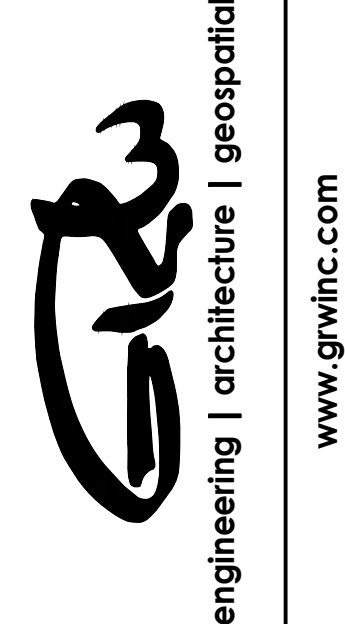


KEYNOTE: SHEET KEYNOTES:

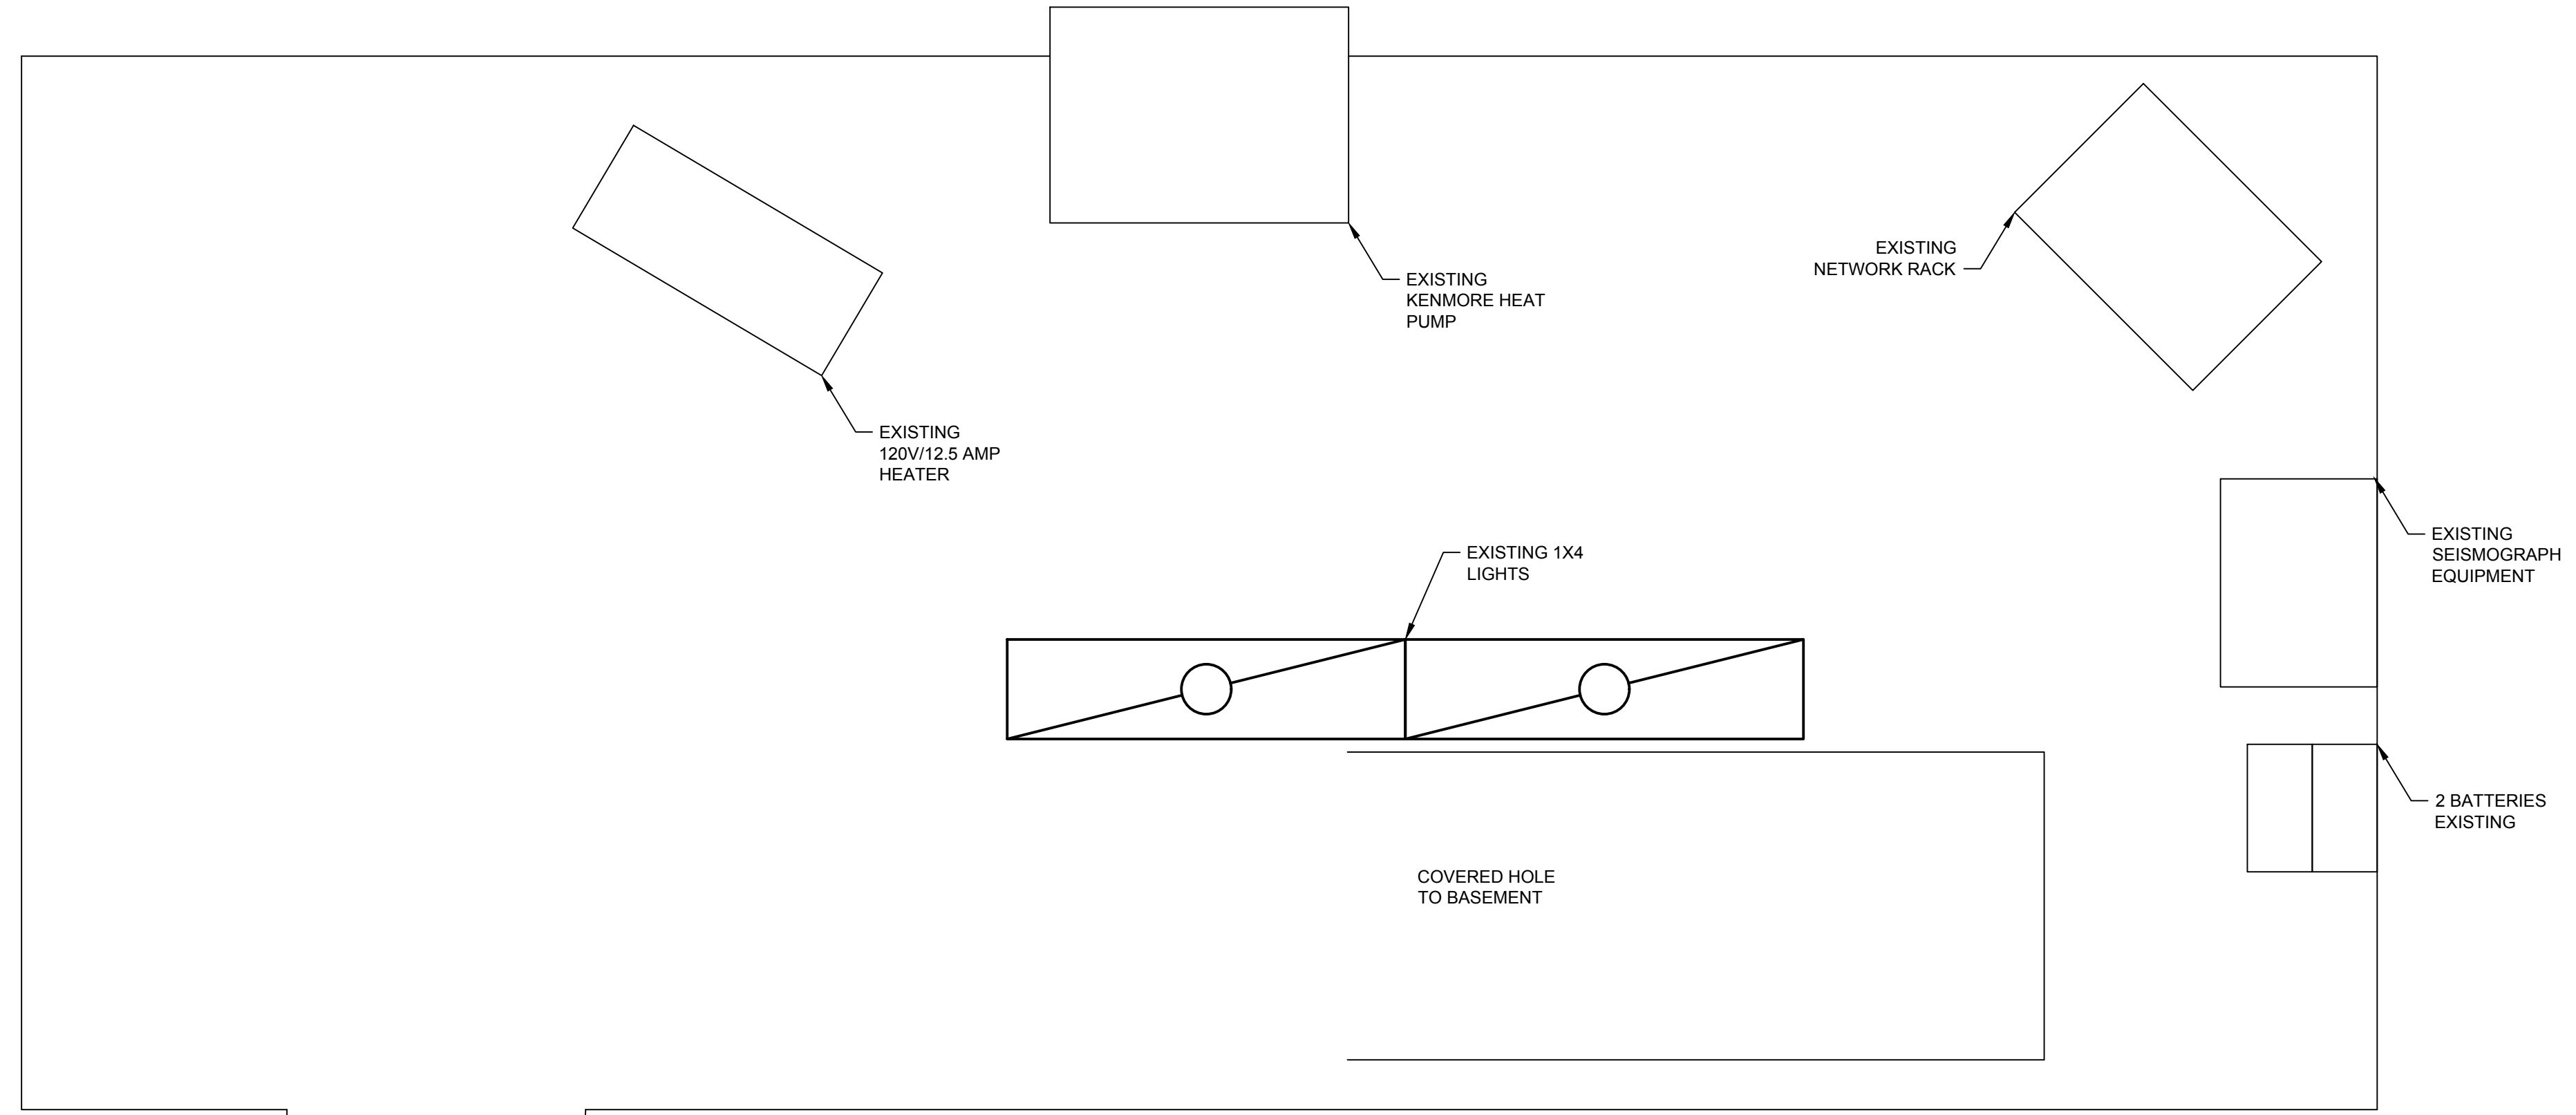- 1. ANCHOR CABINET TO CONCRETE FLOOR SLAB.



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WYANDOTTE CAVE-
SEISMOGRAPH BUILDING NEW ELECTRICAL
WYANDOTTE CAVE (LARGE)
LEAVENWORTH, INDIANA

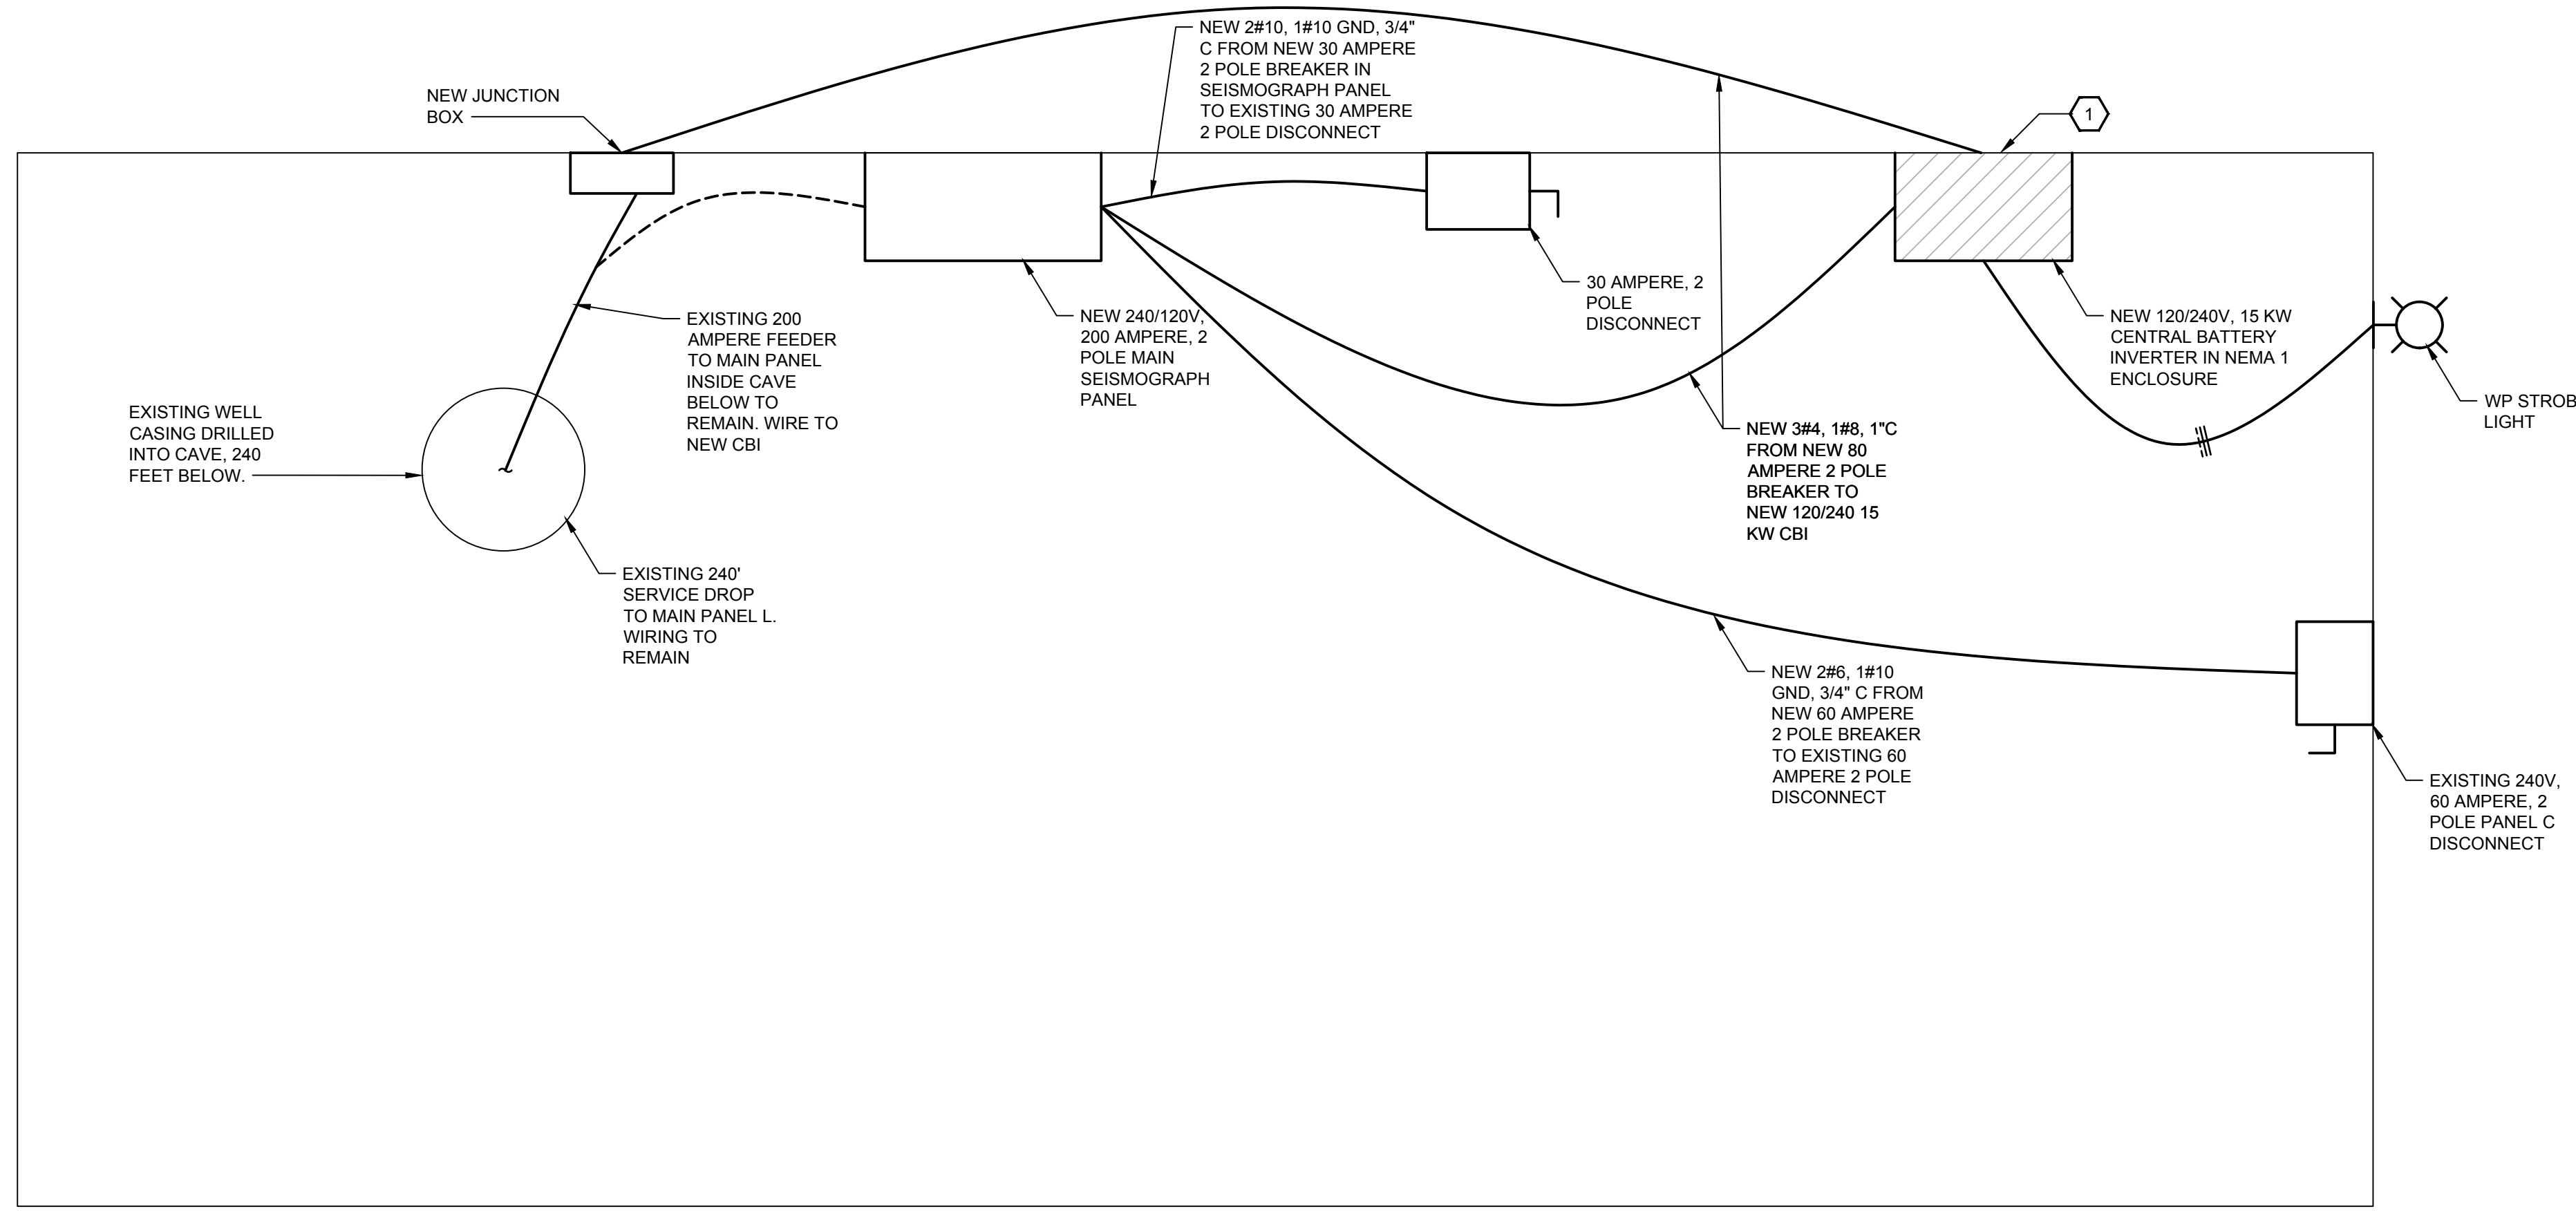DESIGNED	DRC
DRAWN	RHR
REVIEWED	WLM
APPROVED	WLM

NO.	REVISIONS	DATE	BY
	DESCRIPTION		

SCALE CHECK: THIS MARK SHOULD MEASURE EXACTLY 1" WHEN PLOTTED

DATE: SEPTEMBER 2018
SCALE: NOT TO SCALE
SHEET NO.


E-412

BID DOCUMENTS


PLOTTED BY: bramsey

PRINTED: 9/26/2018 @ 9:00AM


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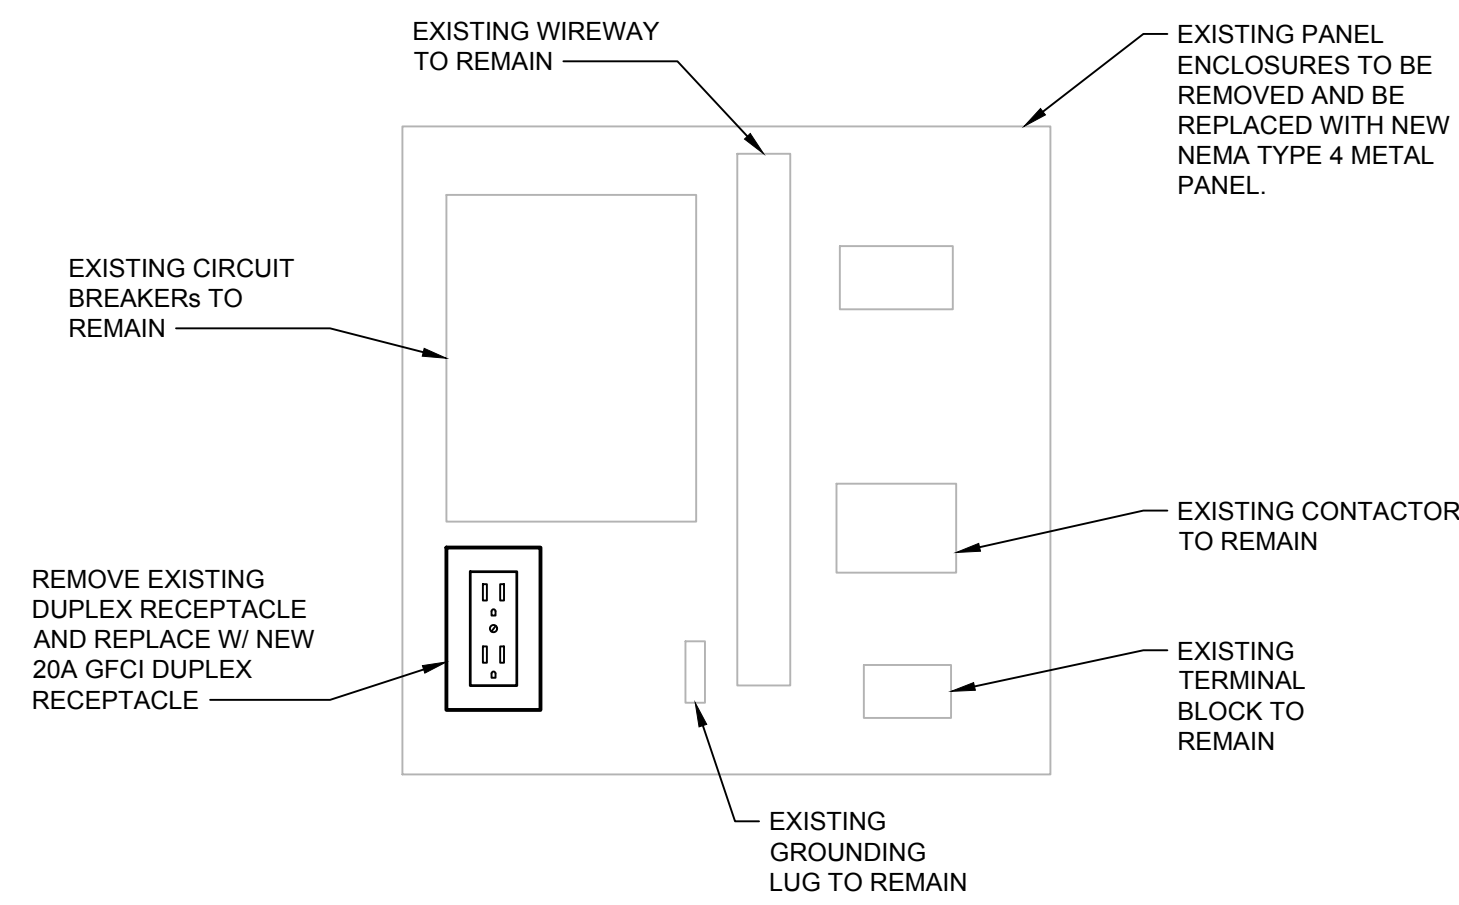
1 NEW LIGHT FIXTURE TYPE "A" MOUNTING DETAIL
NOT TO SCALE

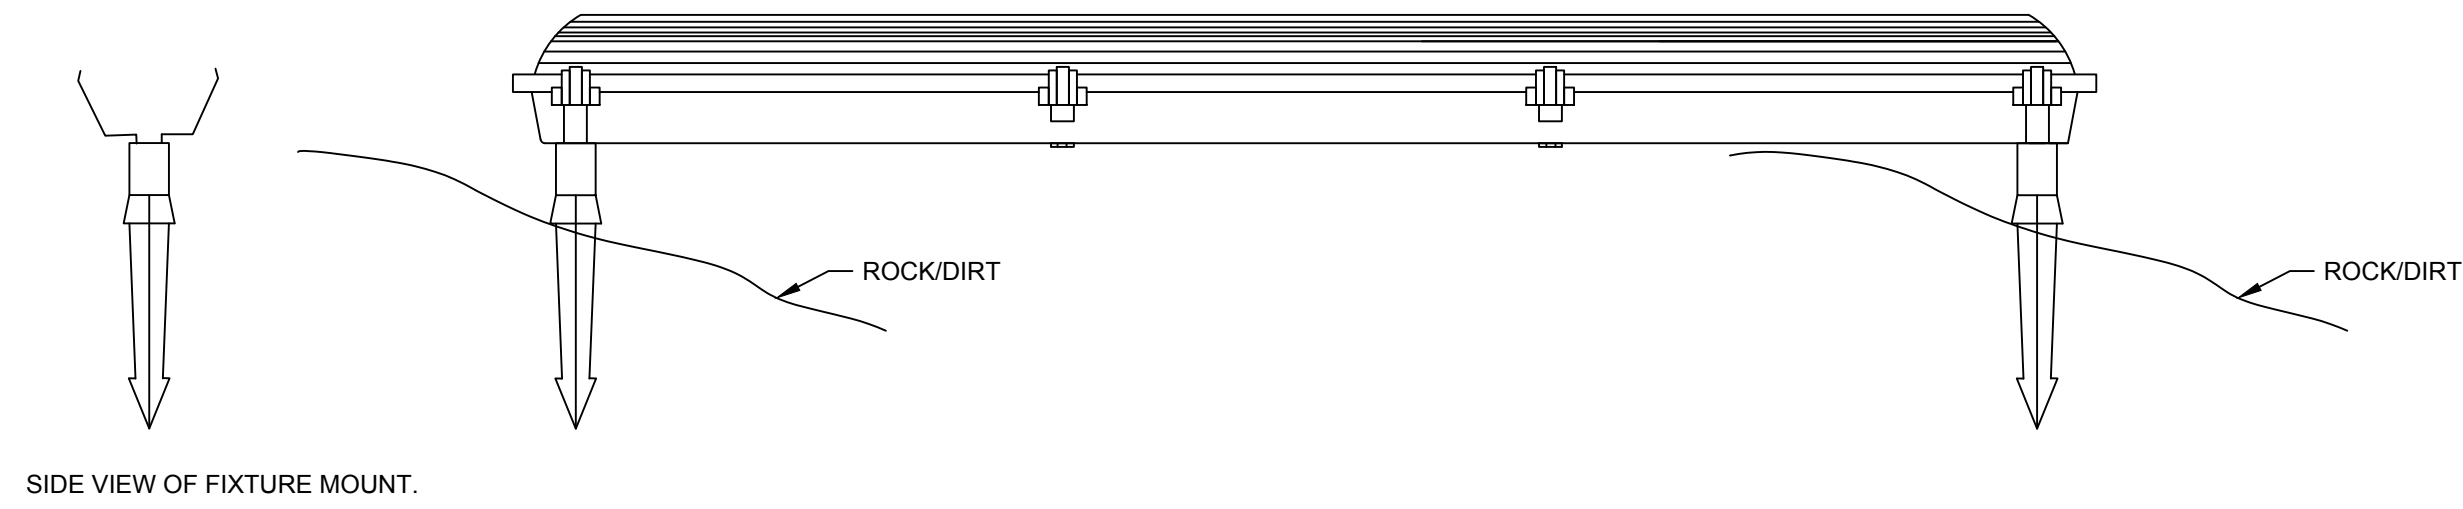


2 NEW LIGHT FIXTURE TYPE "B" MOUNTING DETAIL
NOT TO SCALE

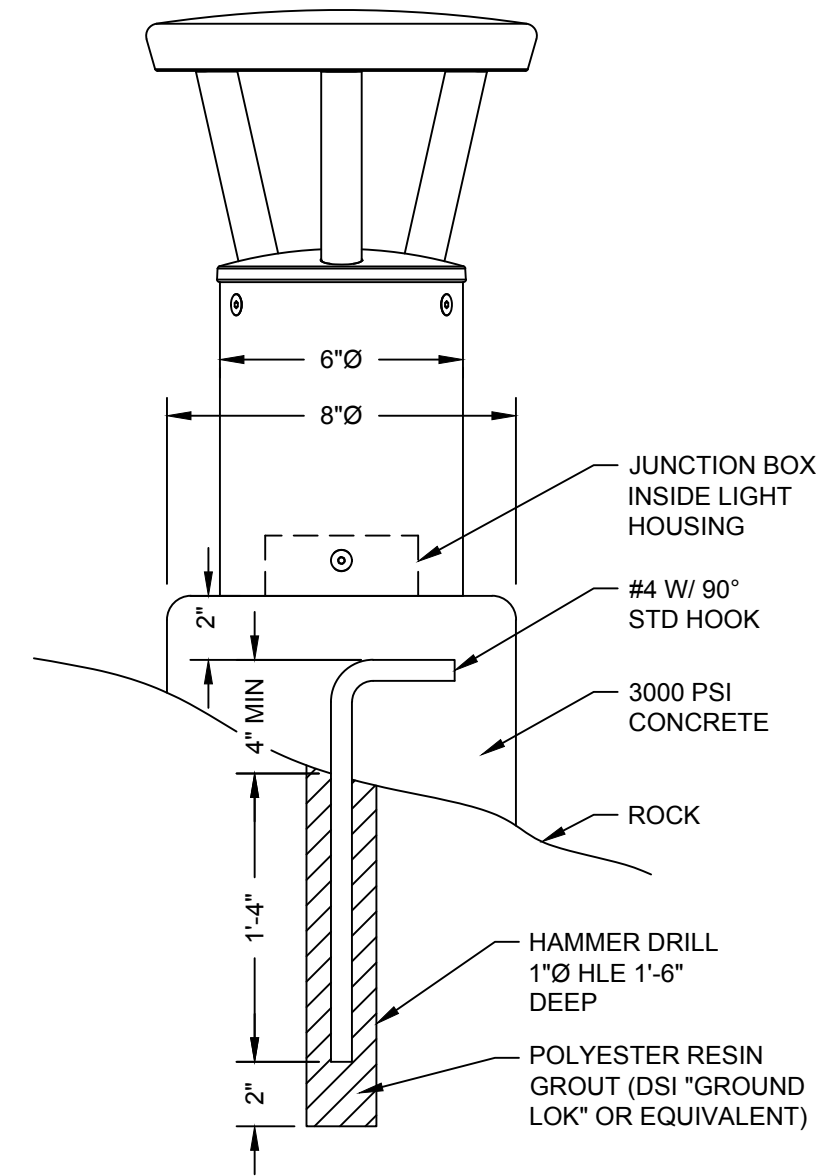



3 NEW LIGHT FIXTURE TYPE "C" MOUNTING DETAIL
NOT TO SCALE

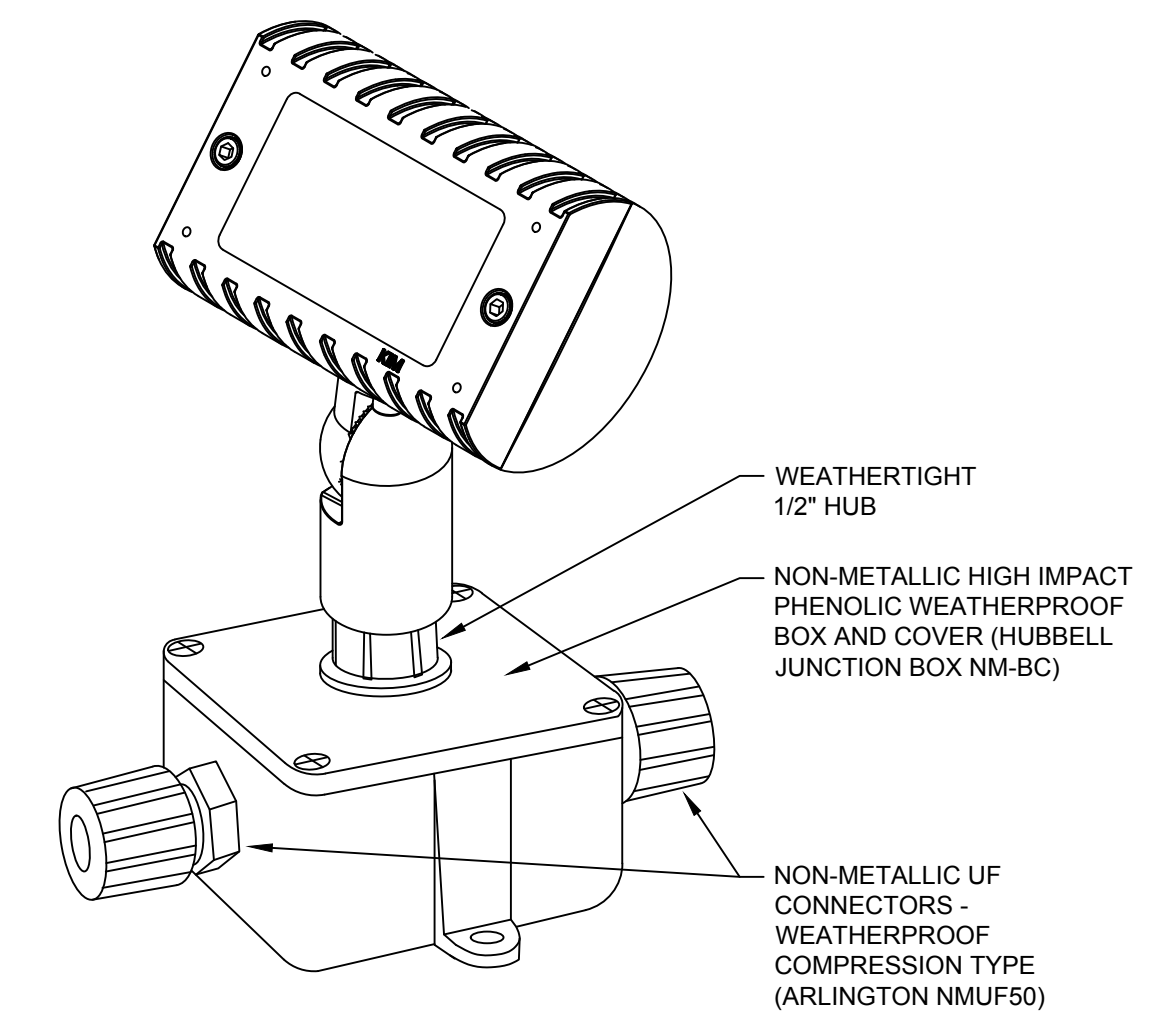

4 TYPICAL PANEL MODIFICATIONS
NOT TO SCALE

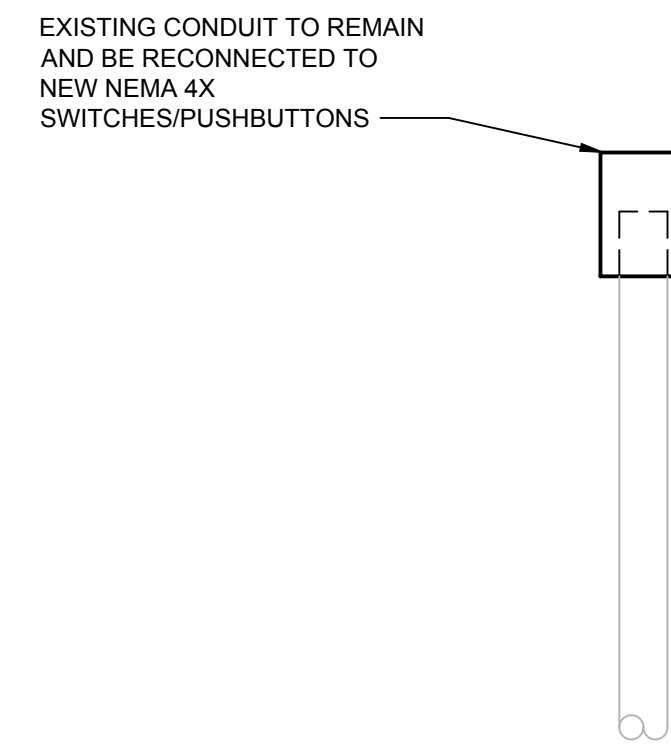

5 TYPICAL NEW SWITCH STATION
NOT TO SCALE

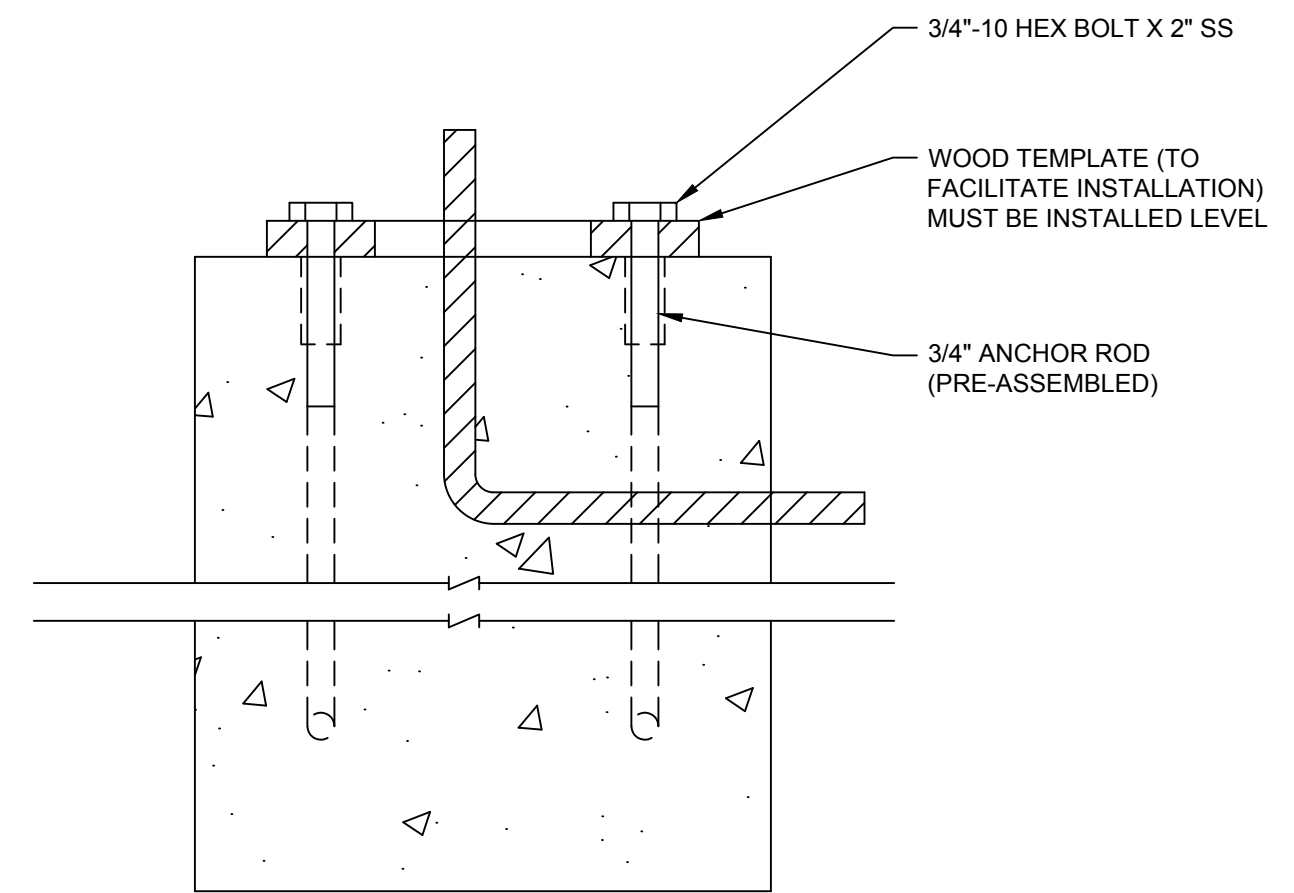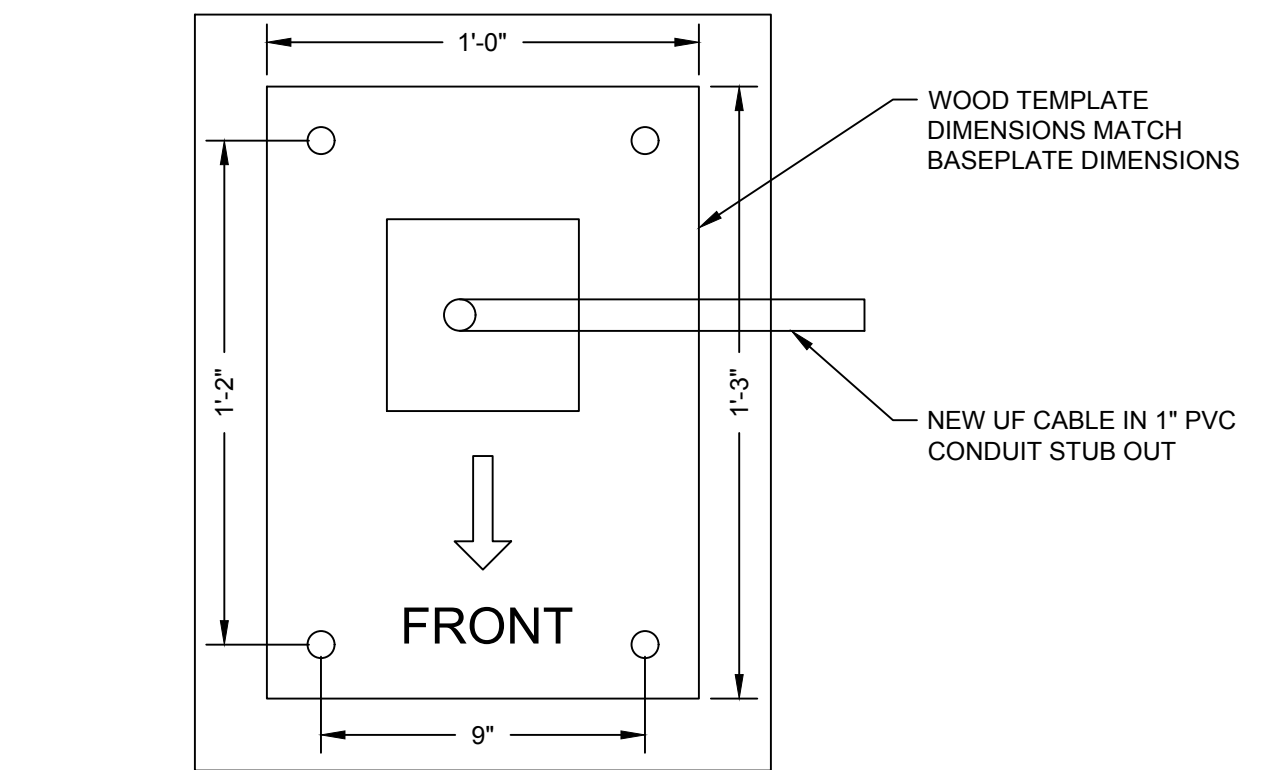


SECTION A

6 NEW POLE BASE FOUNDATION DETAIL
NOT TO SCALE



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ELECTRICAL DETAILS I
WYANDOTTE CAVE (LARGE)
LEAVENWORTH, INDIANA

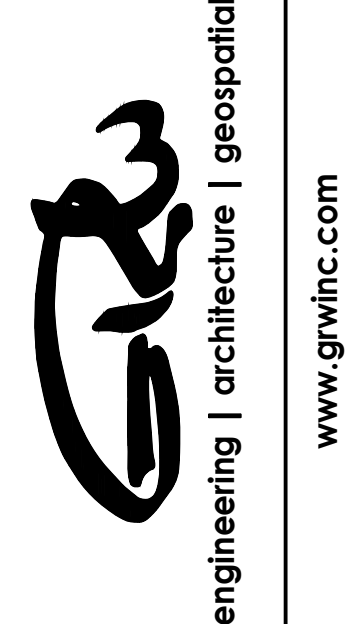DESIGNED BY	DRC
DRAWN BY	RHR
REVIEWED BY	WLM
APPROVED BY	WLM


NO.	DATE	DESCRIPTION

SCALE CHECK: _____ THIS MARK SHOULD MEASURE EXACTLY 1" WHEN PLOTTED

DATE: SEPTEMBER 2018
SCALE: NOT TO SCALE
SHEET NO.

E-501


BID DOCUMENTS

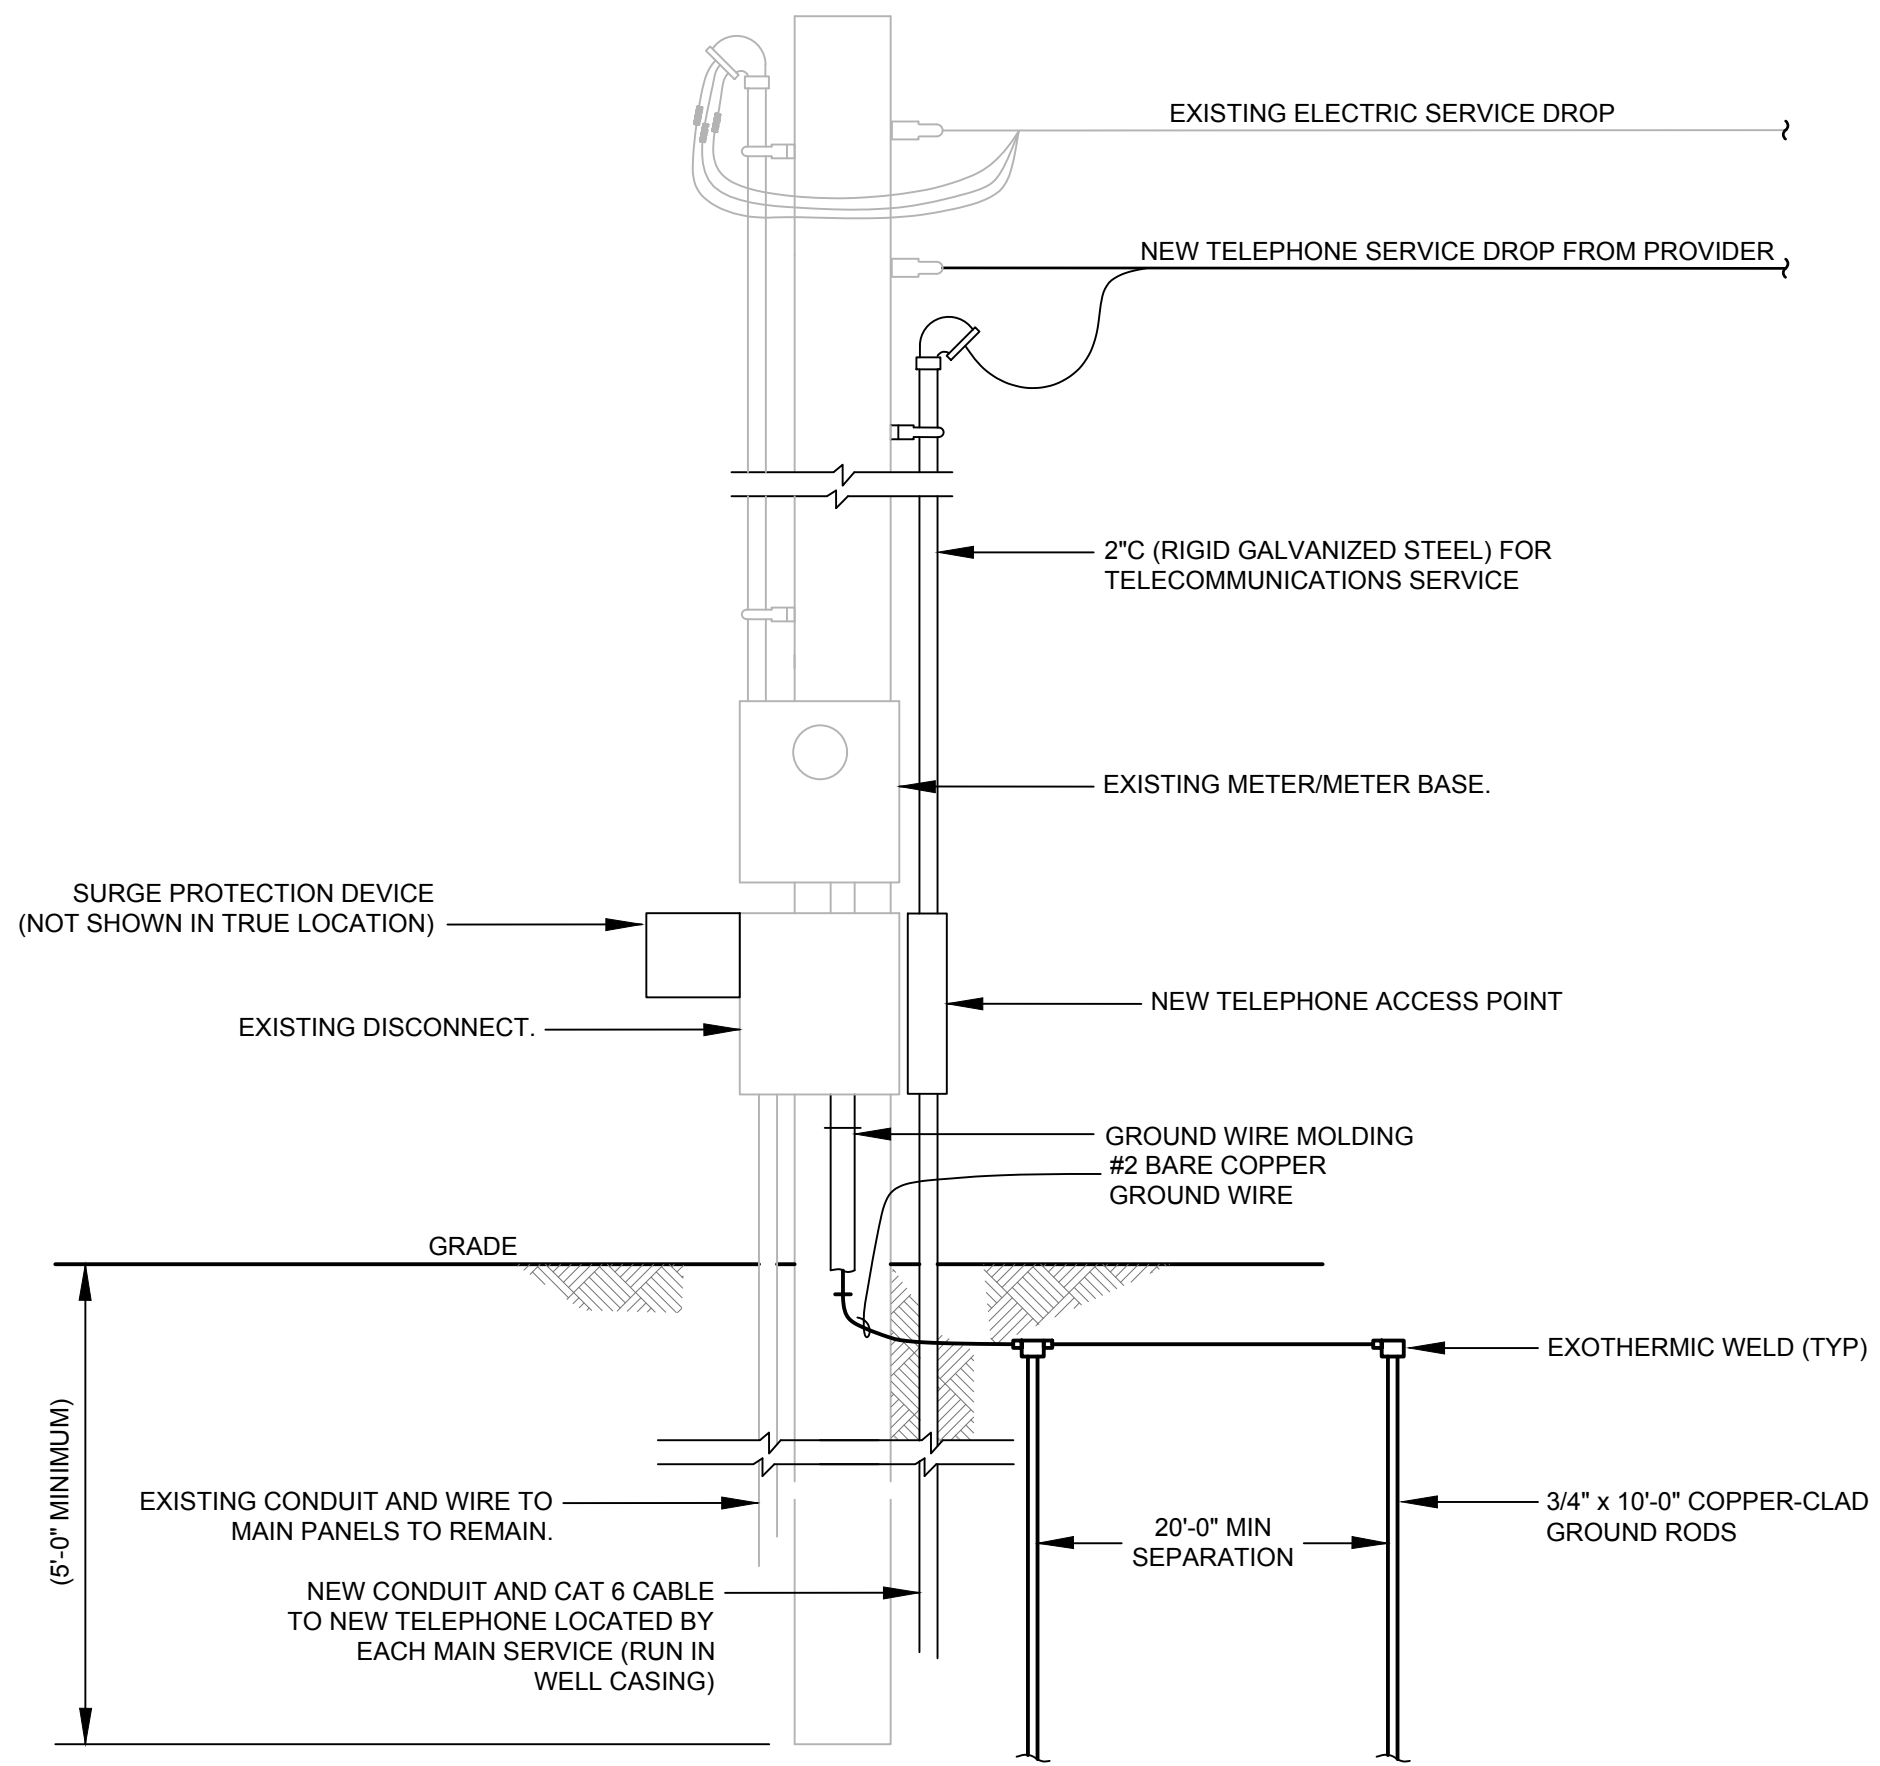

1 BASE BID AND ALT. 2 EXISTING SERVICE POLE MODIFICATIONS
NOT TO SCALE

GENERAL NOTES:

1. UNDERGROUND CONDUIT FROM THE SERVICE RISER POLE TO THE CAVE WELL CASING IS EXISTING.
2. MOUNT SPD TO SERVICE POLE.

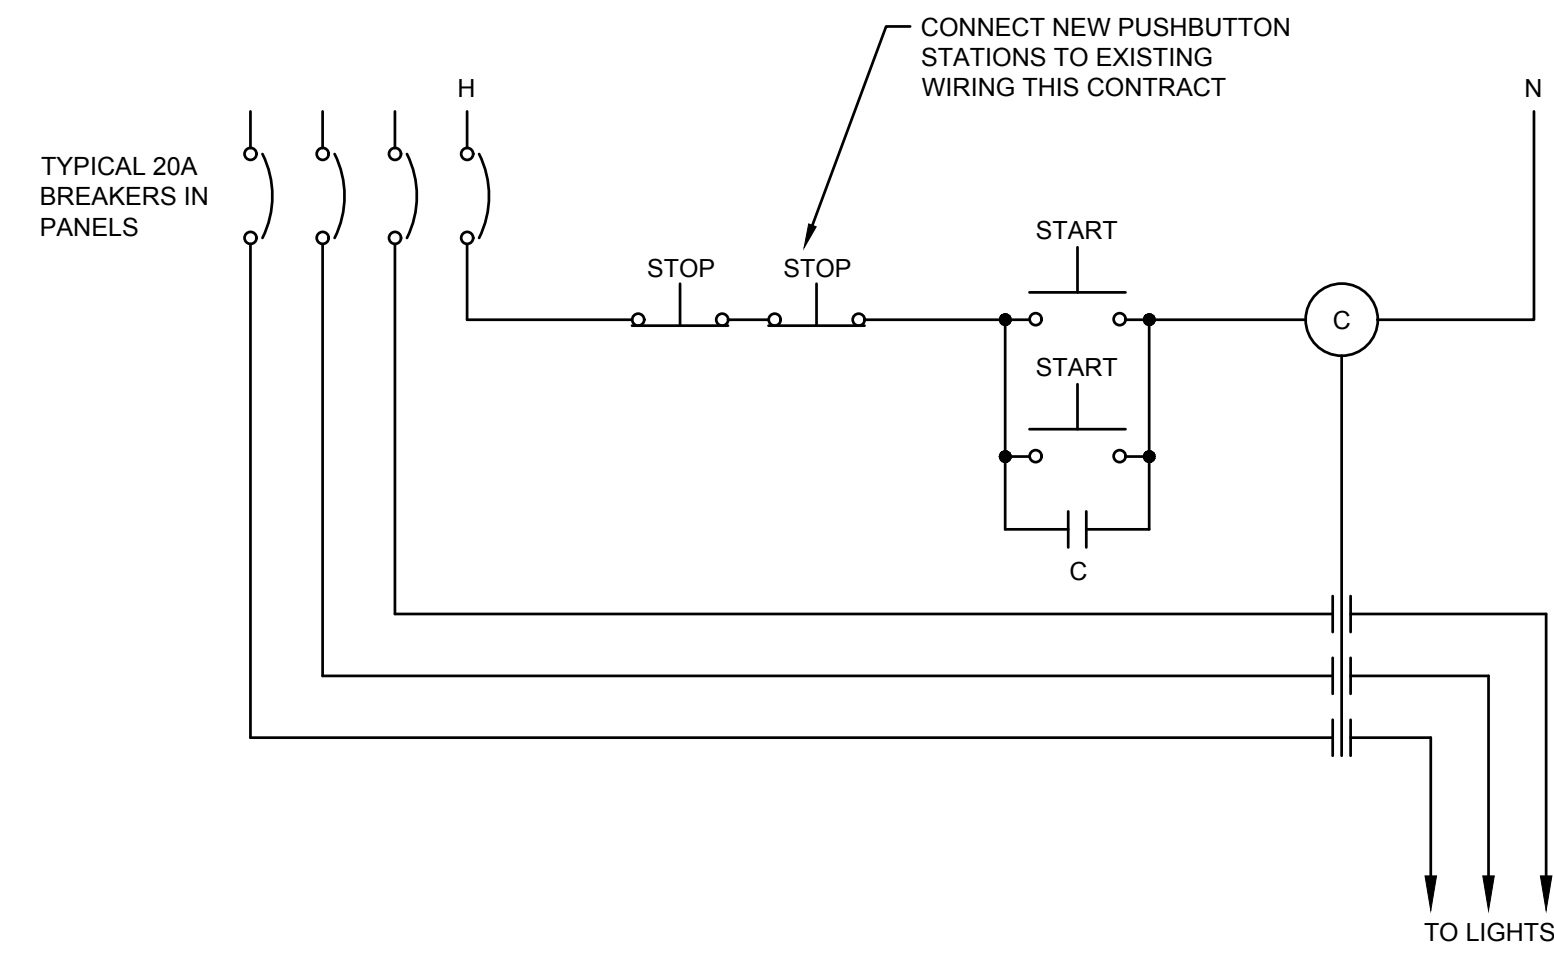


TYPICAL WIRING FOR PUSHBUTTON LIGHTING CONTROL STATIONS
NOT TO SCALE

GENERAL NOTES:

1. FOR GENERAL REFERENCE ONLY. ALL CONTROL WIRING SHALL MATCH EXISTING USING NEW UF CABLE SUPPORTED EVERY 4.5' IN ACCORDANCE TO THE NEC.



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ELECTRICAL DETAILS II
WYANDOTTE CAVE (LARGE)
LEAVENWORTH, INDIANA

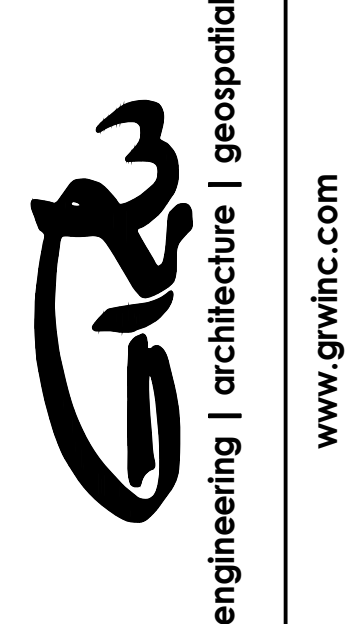DESIGNED	DRC
DRAWN	RHR
REVIEWED	WLM
APPROVED	WLM

NO.	REVISIONS DESCRIPTION	DATE	BY

SCALE CHECK: _____ THIS MARK SHOULD MEASURE EXACTLY 1" WHEN PLOTTED

DATE: SEPTEMBER 2018
SCALE: NOT TO SCALE
SHEET NO.

E-502

PLOTTED BY: bramsey


PRINTED: 9/26/2018 @ 9:00AM

FILE NAME: G:\485\INR-Bat Cave\Working Drawings\AutoCAD\Large Cave\4495-E-601.dwg

BASE BID NEW LIGHT FIXTURE SCHEDULE										
FIXTURE TYPE	DESCRIPTION	LUMEN SOURCE				VOLTS	MOUNTING		MANUFACTURER	MODEL NUMBER
		COLOR TEMP	TYPE	LUMENS	WATTS		TYPE	HEIGHT		
A	1X8 LED LXEM	3000K	LED	8,095	66.6	120	GROUND	N/A	COLUMBIA LIGHTING	LXEM8-30LW-RFA-EU-DWH-XEDPM
B	14" BOLLARD LED FIXTURE	3000K	LED	950	10	120	GROUND	N/A	FIRST LIGHT TECHNOLOGIES	PLB-AC-BZ-FT-30K-UV7
C	DIRECTIONAL FLOOD LED FIXTURE	3000K	LED	1,984	25	120	GROUND	N/A	HUBBELL	FSL-10L-25-3K-W-U-K-*
D	LED STEP LIGHT	3000K	LED	167	11.5	120	WALL INSERT	12"	KIM LIGHTING	EL807/9L3KUV

ALT. 1 NEW LIGHT FIXTURE SCHEDULE										
FIXTURE TYPE	DESCRIPTION	LUMEN SOURCE				VOLTS	MOUNTING		MANUFACTURER	MODEL NUMBER
		COLOR TEMP	TYPE	LUMENS	WATTS		TYPE	HEIGHT		
A	1X8 LED LXEM	3000K	LED	8,095	66.6	120	GROUND	N/A	COLUMBIA LIGHTING	LXEM8-30LW-RFA-EU-DWH-XEDPM
B	14" BOLLARD LED FIXTURE	3000K	LED	950	10	120	GROUND	N/A	FIRST LIGHT TECHNOLOGIES	PLB-AC-BZ-FT-30K-UV7
C	DIRECTIONAL FLOOD LED FIXTURE	3000K	LED	1,984	25	120	GROUND	N/A	HUBBELL	FSL-10L-25-3K-W-U-K-*


ALT. 2 NEW LIGHT FIXTURE SCHEDULE										
FIXTURE TYPE	DESCRIPTION	LUMEN SOURCE				VOLTS	MOUNTING		MANUFACTURER	MODEL NUMBER
		COLOR TEMP	TYPE	LUMENS	WATTS		TYPE	HEIGHT		
A	1X8 LED LXEM	3000K	LED	8,095	66.6	120	GROUND	N/A	COLUMBIA LIGHTING	LXEM8-30LW-RFA-EU-DWH-XEDPM
B	14" BOLLARD LED FIXTURE	3000K	LED	950	10	120	GROUND	N/A	FIRST LIGHT TECHNOLOGIES	PLB-AC-BZ-FT-30K-UV7
C	DIRECTIONAL FLOOD LED FIXTURE	3000K	LED	1,984	25	120	GROUND	N/A	HUBBELL	FSL-10L-25-3K-W-U-K-*
E	12" LED POLE LIGHT	3000K	LED	7792	74.8	120	POLE	12"	STRUCTURA	EVO-12-A12-LIN-16-LIN-P1/S-MOD

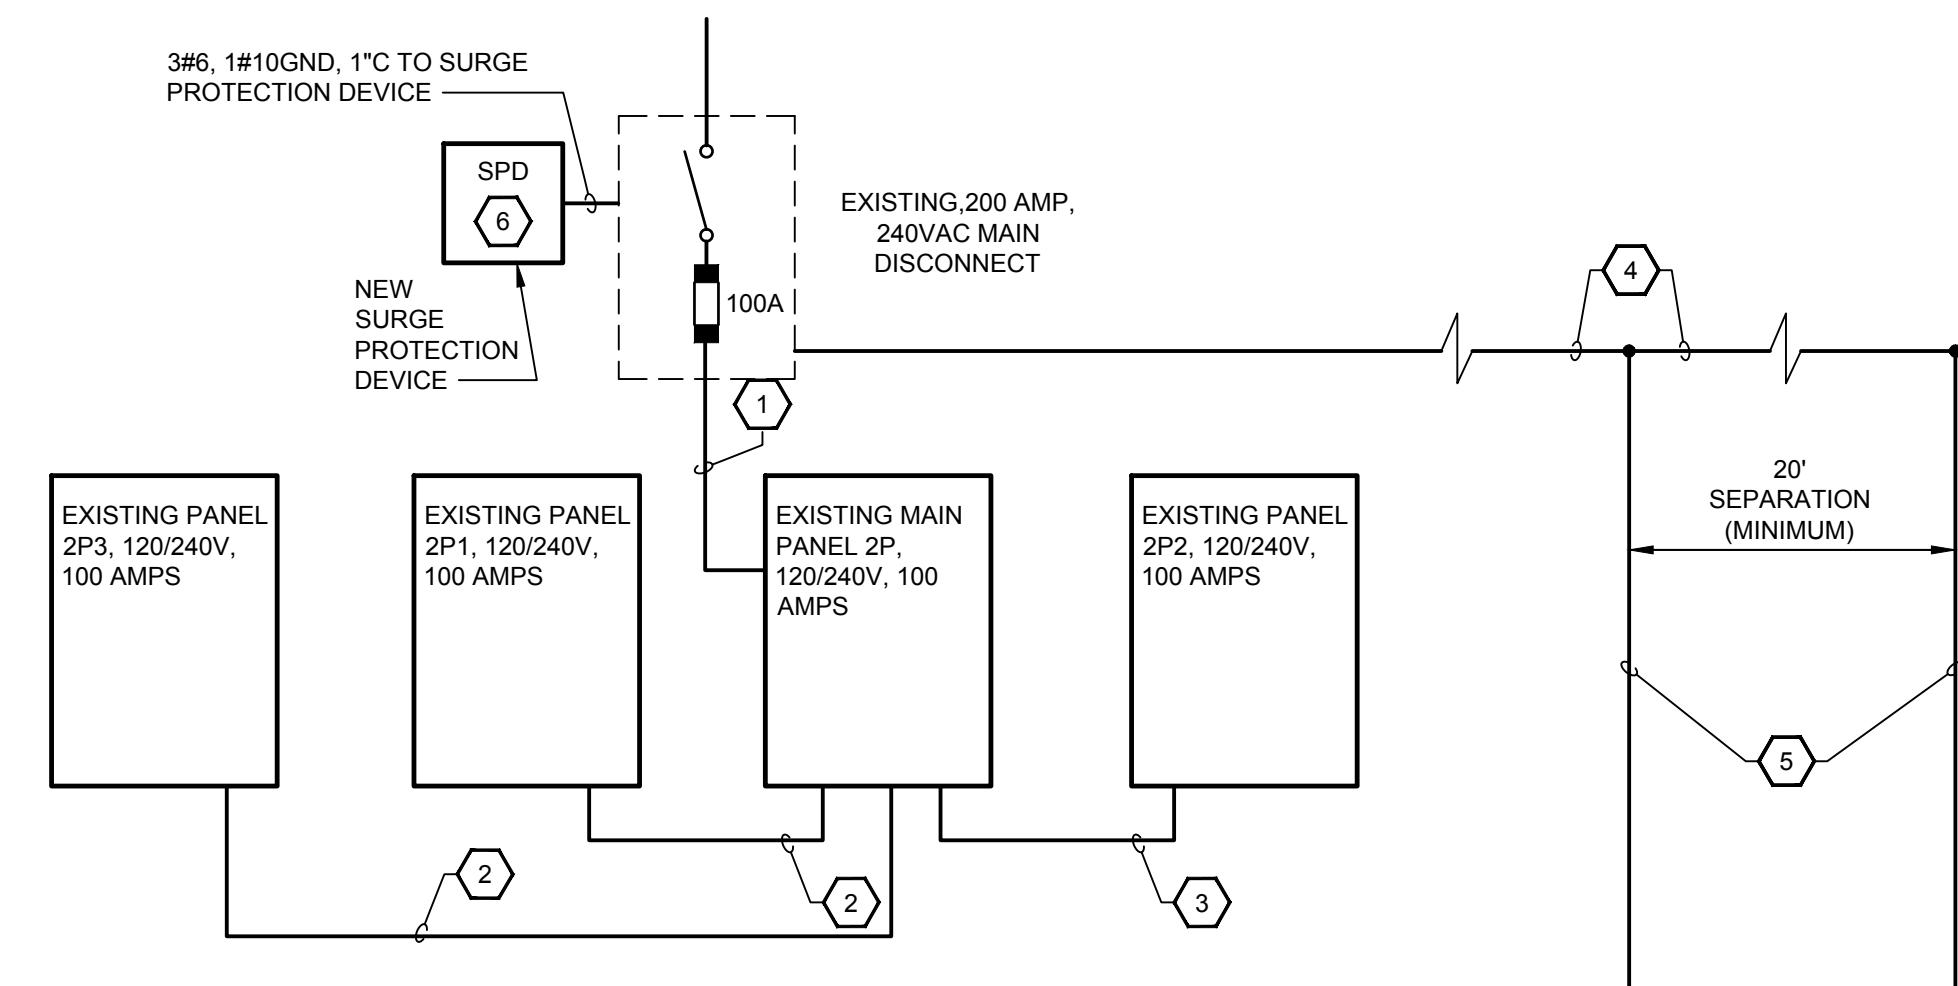

1 BASE BID ONE LINE
NOT TO SCALE

KEYNOTES TO ONE LINE DIAGRAMS:


- EXISTING WIRE AND CONDUIT TO REMAIN.
- EXISTING 3#6, 1#6 GND, 1" PVC TO REMAIN.
- EXISTING 3#1, 1#10 GND, 1 1/2" PVC TO REMAIN.
- NEW BARE #2 COPPER BURIED 30".
- DRIVE ALL RODS TO 30" BELOW GRADE (INCLUDING EXISTING ROD).
- FURNISH AND INSTALL A NEW TYPE 2 SPD THIS CONTRACT.

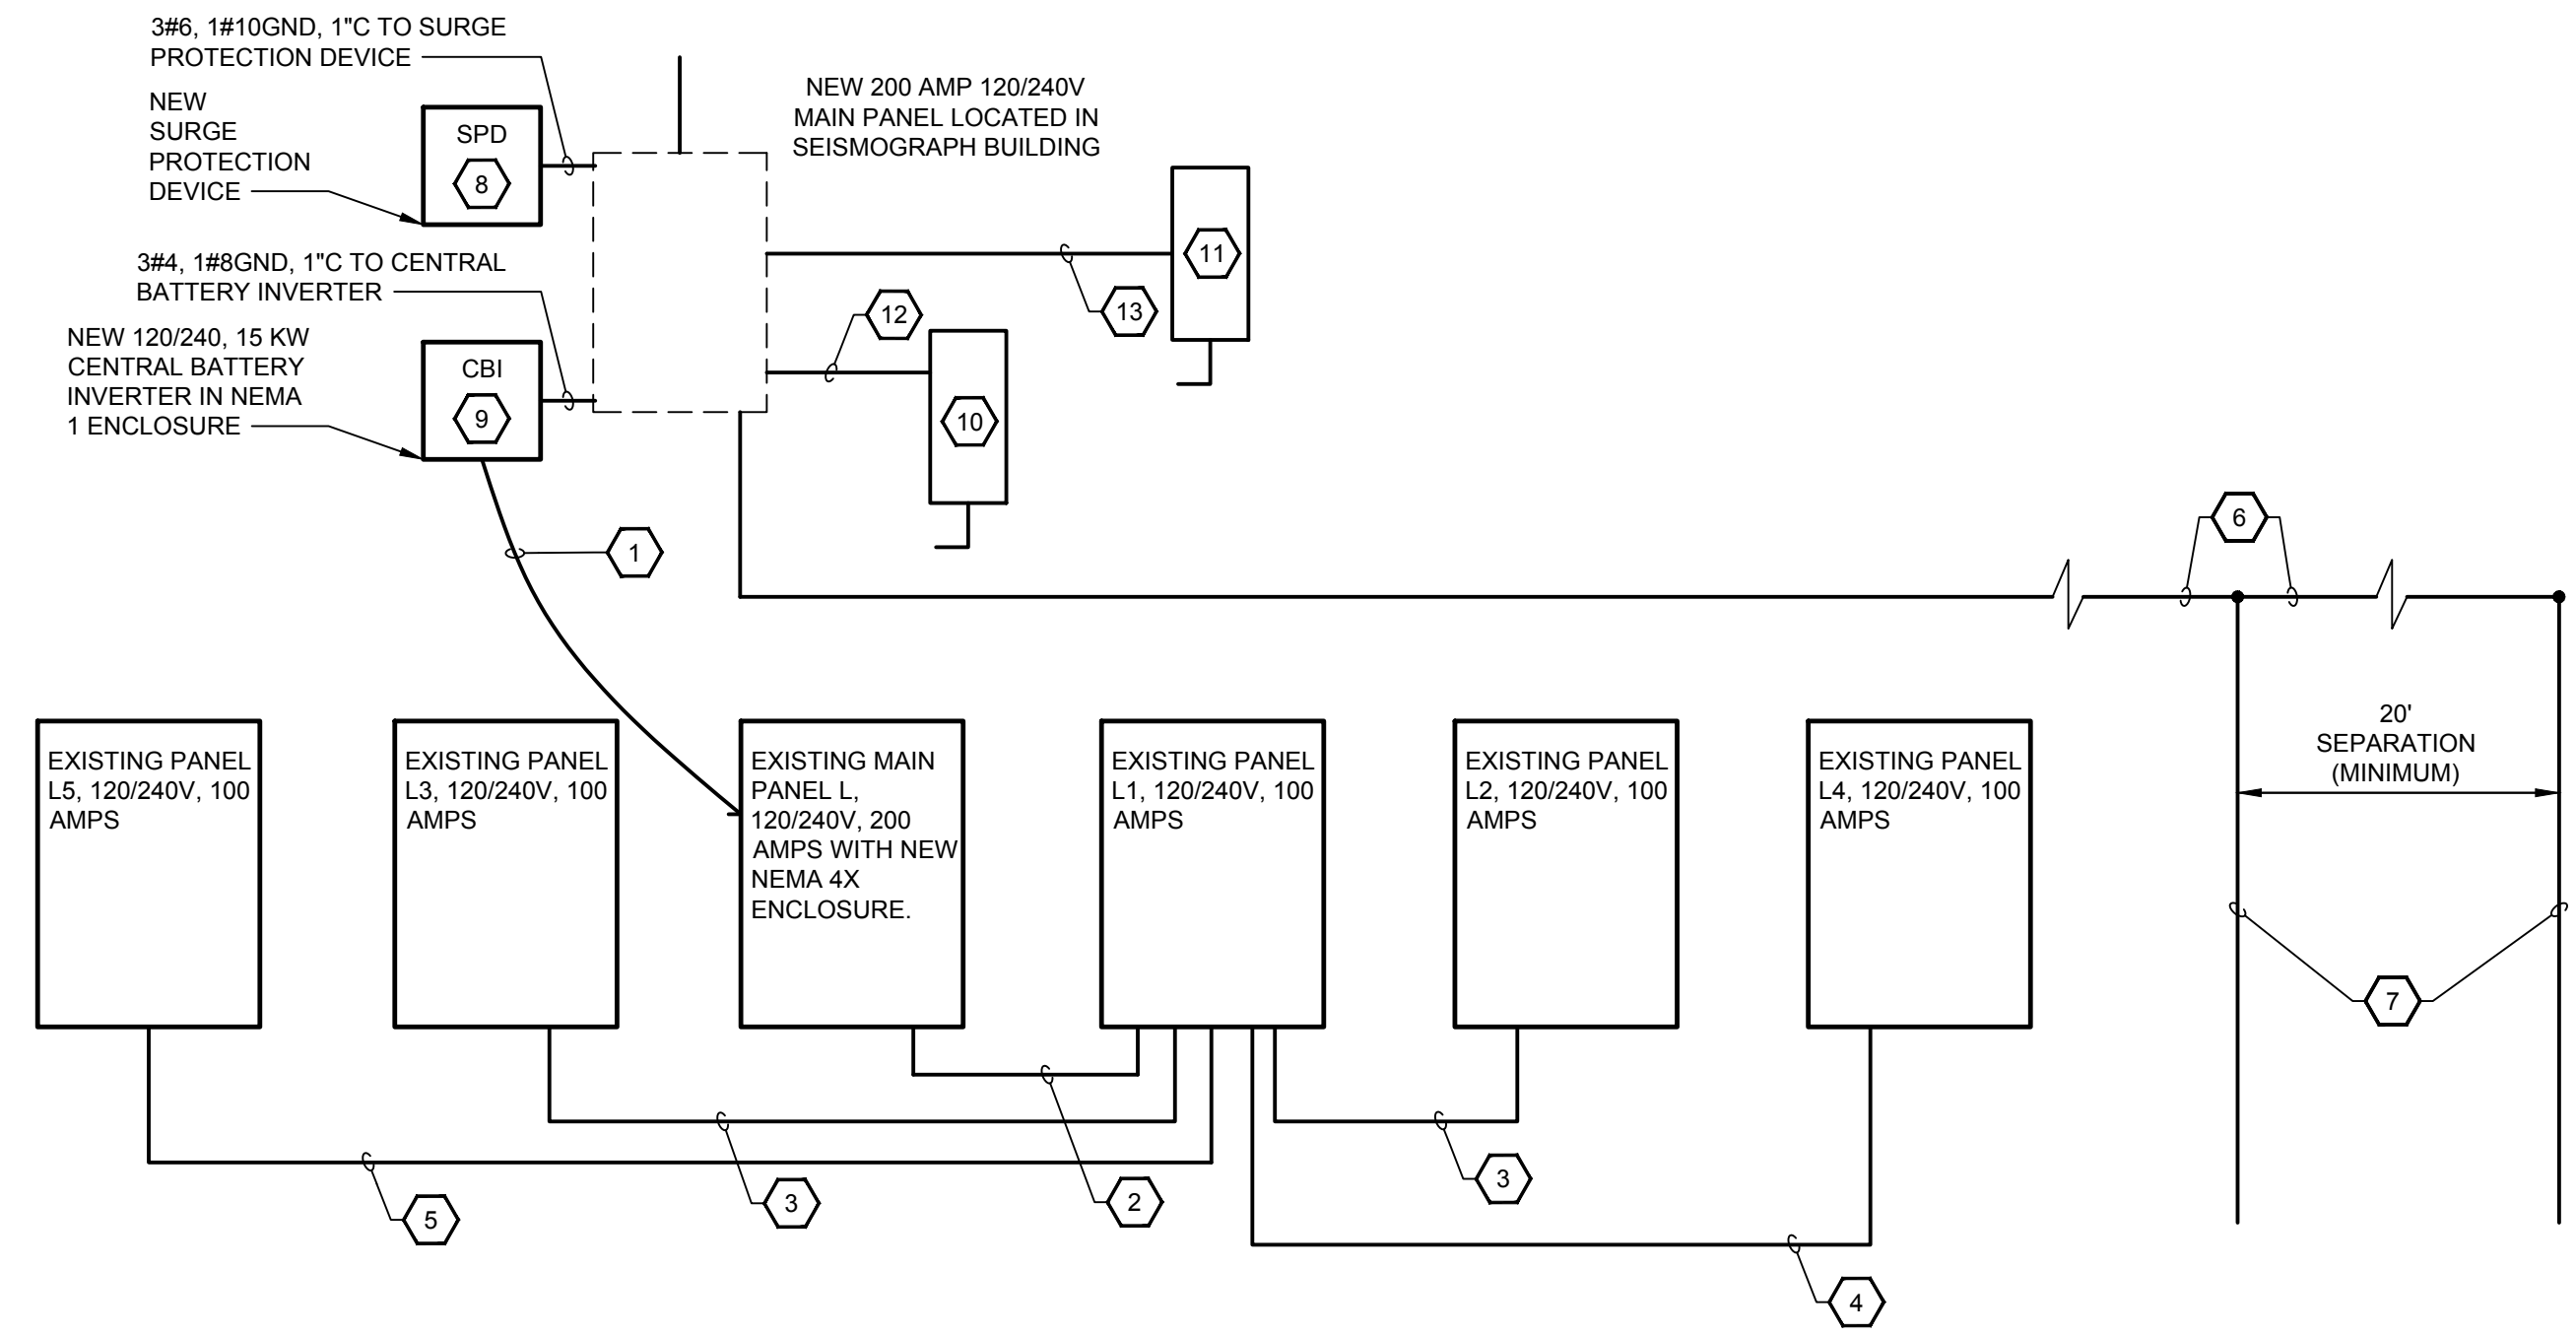

2 ALT. 1 ONE LINE
NOT TO SCALE

KEYNOTES TO ONE LINE DIAGRAMS:

- EXISTING WIRE AND CONDUIT TO REMAIN.
- EXISTING 3#3/0, 1#10 GND, 2" PVC TO REMAIN.
- EXISTING 3#6, 1#10 GND, 1" PVC TO REMAIN.
- EXISTING 3#1, 1#10 GND, 1 1/2" PVC TO REMAIN.
- EXISTING 3#4, 1#10 GND, 1" PVC TO REMAIN.
- NEW BARE #2 COPPER BURIED 30".
- DRIVE ALL RODS TO 30" BELOW GRADE (INCLUDING EXISTING ROD).
- FURNISH AND INSTALL A NEW TYPE 2 SPD THIS CONTRACT.
- NEW 120/240, 15 KW CENTRAL BATTERY INVERTER IN NEMA 1 ENCLOSURE.
- EXISTING 30 AMP 2 POLE DISCONNECT.
- EXISTING 60 AMP 2 POLE DISCONNECT.
- NEW 2#10, 1#10 GND, 3/4" C.
- NEW 2#6, 1#10 GND, 3/4" C.

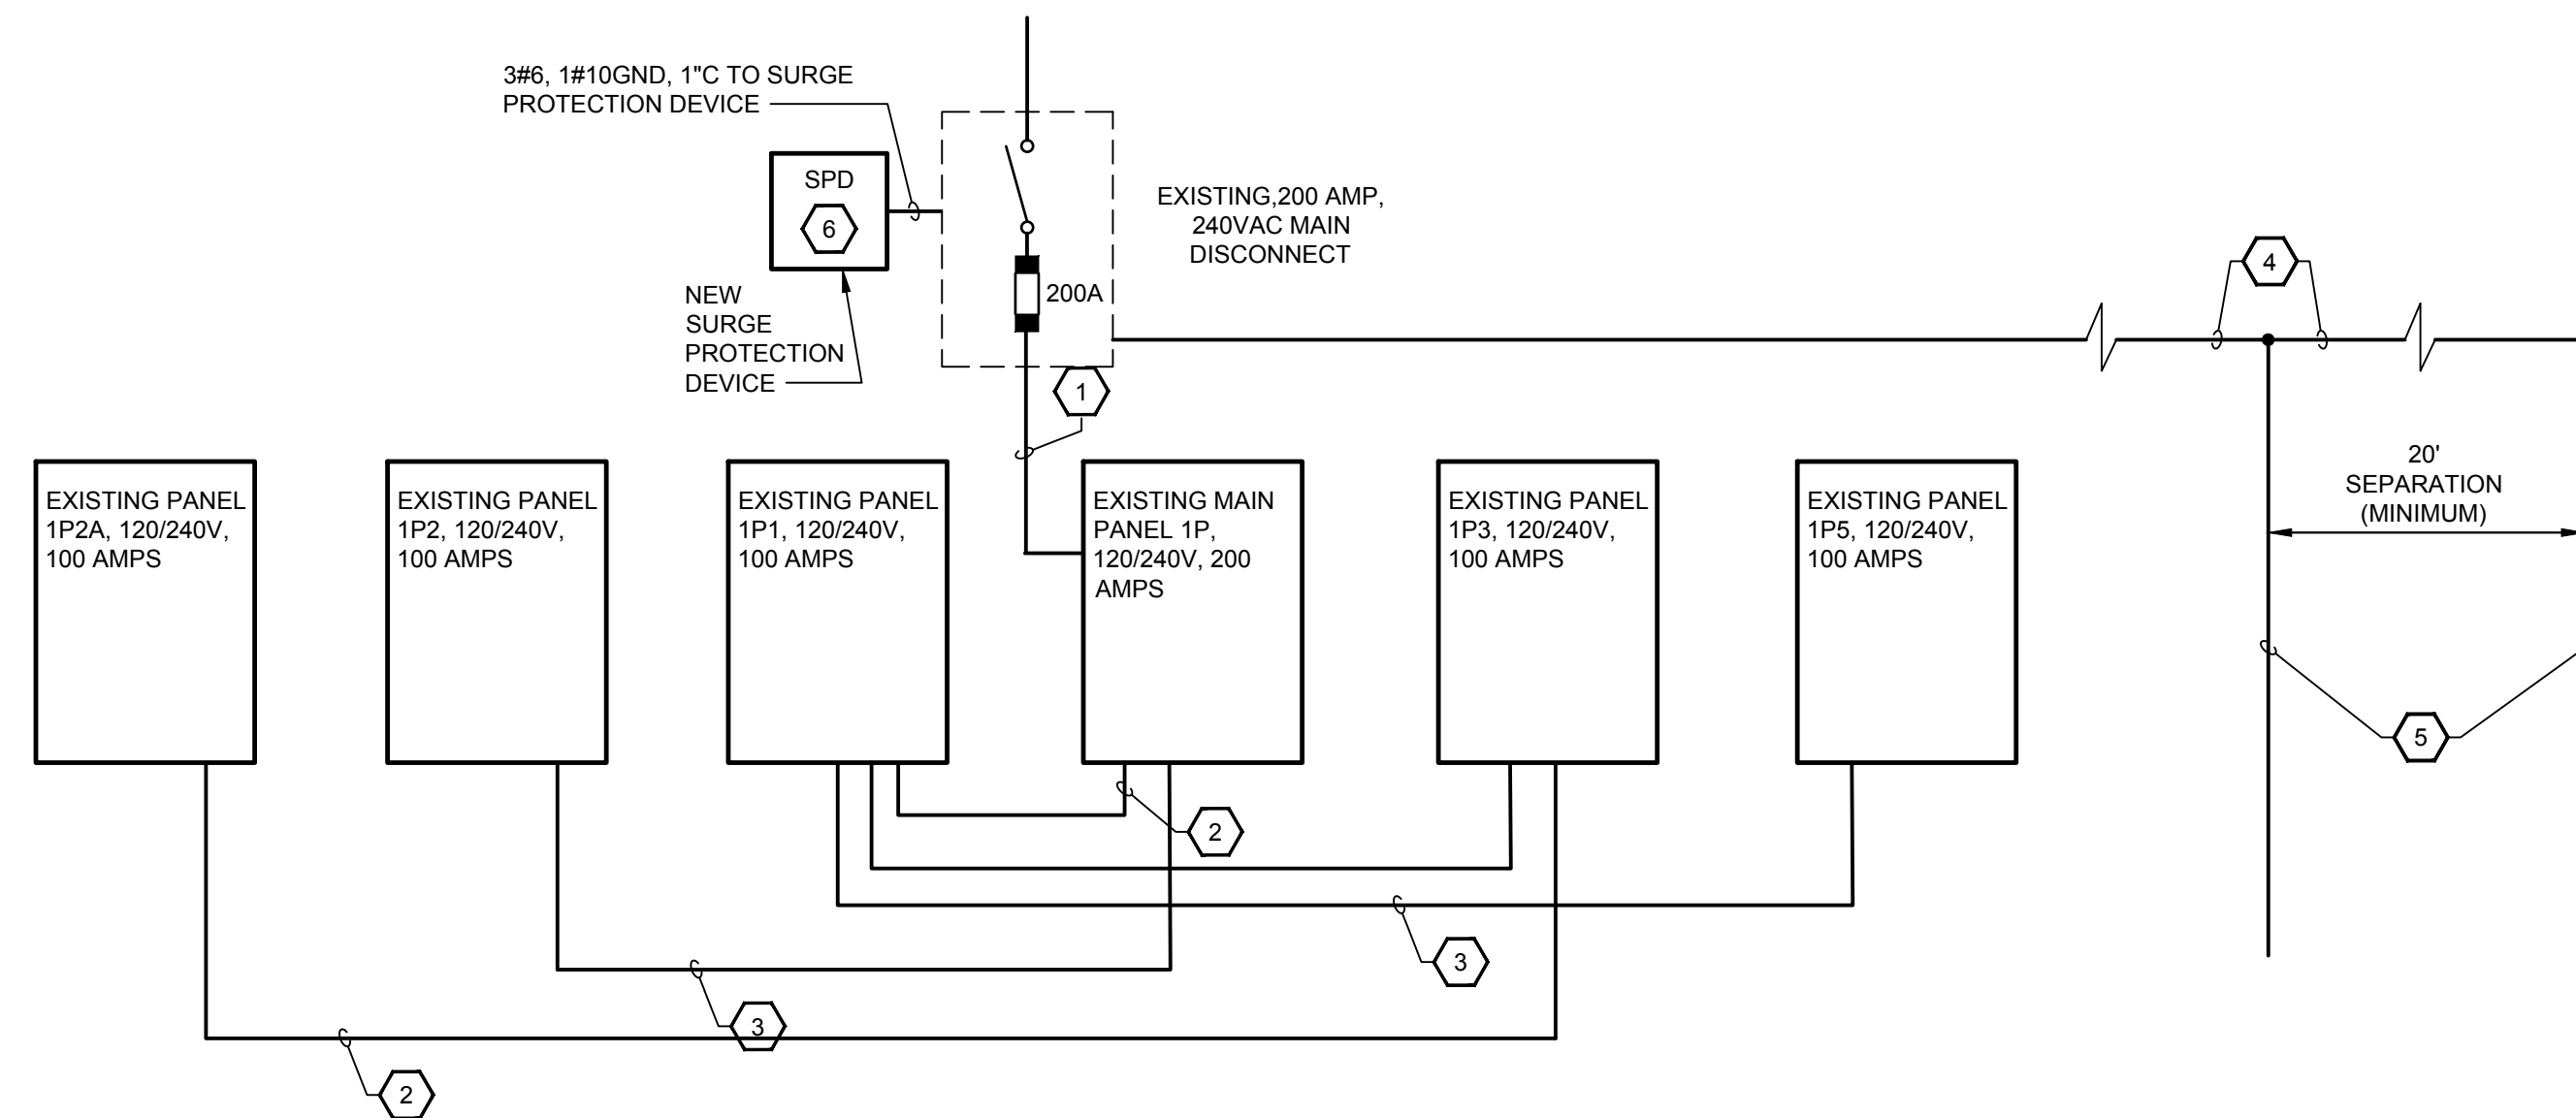


3 ALT. 2 ONE LINE
NOT TO SCALE

KEYNOTES TO ONE LINE DIAGRAMS:

- EXISTING WIRE AND CONDUIT TO REMAIN.
- EXISTING 3#6, 1#10 GND, 1" PVC TO REMAIN.
- EXISTING 3#1, 1#10 GND, 1 1/2" PVC TO REMAIN.
- NEW BARE #2 COPPER BURIED 30".
- DRIVE ALL RODS TO 30" BELOW GRADE (INCLUDING EXISTING ROD).
- FURNISH AND INSTALL A NEW TYPE 2 SPD THIS CONTRACT.



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ELECTRICAL ONE LINES AND SCHEDULES
WYANDOTTE CAVE (LARGE)
LEAVENWORTH, INDIANA

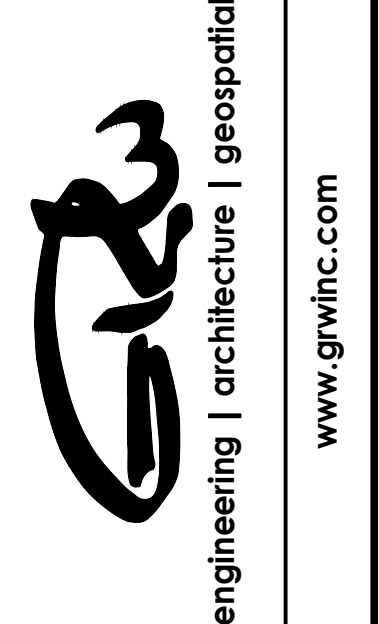DESIGNED	DRC	DRAWN	RHR	REVIEWED	WLM	APPROVED	WLM

DATE: SEPTEMBER 2018
SCALE: NOT TO SCALE
SHEET NO.

E-601

BID DOCUMENTS

PANEL BOARD SCHEDULE			
EXISTING LOAD CENTER - "L1"			
SWITCH STATIONS:			
MAIN BREAKER: 2P-200 AMP			
CIR.	BREAKER POLE/AMPS	FEEDER	AMPS
L1-1	2P-60	PANEL - L2	6
L1-2	2P-60	PANEL - L4	23
L1-3	2P-60	PANEL - L3	19
L1-4	2P-60	PANEL - L5	11
L1-5	1P-15	HEATER	1
L1-6	1P-20	NEW GFCI RECEPTACLE	1.6
CONTD			

PANEL BOARD SCHEDULE			
EXISTING LOAD CENTER - "L1" CONT'D			
SWITCH STATIONS: #7 TUMBLER (L1-7)			
MAIN BREAKER: 2P-200 AMP			
CIR.	BREAKER POLE/AMPS	FIXTURE QUANTITY	AMPS
L1-7	1P-20	A 4 B 3 C 6	3.7
L1-8	1P-20	SPARE	-
L1-9	1P-20	SPARE	-
L1-10	-	-	-
L1-11	-	-	-
L1-12	-	-	-
TOTAL AMPS			65.3

PANEL BOARD SCHEDULE			
EXISTING DISTRIBUTION PANEL - "L2"			
SWITCH STATIONS: #8, #12, & "L2"			
MAIN LUG: 100AMP			
CIR.	BREAKER POLE/AMPS	FIXTURE QUANTITY	AMPS
L2-1	1P-20	- 4 -	.33
L2-2	1P-20	- 6 -	.50
L2-3	1P-20	1 6 1	1.3
L2-4	1P-20	1 3 2	1.2
L2-5	1P-15	HEATER	1
L2-6	1P-20	CONTACTOR/RECEPT	1.6
TOTAL AMPS			5.93

PANEL BOARD SCHEDULE			
EXISTING DISTRIBUTION PANEL - "L3"			
SWITCH STATIONS: #5, #10, & "L3"			
MAIN LUG: 100AMP			
CIR.	BREAKER POLE/AMPS	FIXTURE QUANTITY	AMPS
L3-1	1P-20	6 6 6	4.4
L3-2	1P-20	9 - -	4 5.8
L3-3	1P-20	1 7 5	2.2
L3-4	1P-20	6 - -	3 4.0
L3-5	1P-15	HEATER	1
L3-6	1P-20	CONTACTOR/RECEPT	1.6
TOTAL AMPS			19

PANEL BOARD SCHEDULE			
EXISTING DISTRIBUTION PANEL - "L4"			
SWITCH STATIONS: #11, #23, & "L4"			
MAIN LUG: 100AMP			
CIR.	BREAKER POLE/AMPS	FIXTURE QUANTITY	AMPS
L4-1	1P-20	12 3 6	8.2
L4-2	1P-20	1 9 11	3.6
L4-3	1P-20	2 6 9	3.48
L4-4	1P-20	6 3 6	4.8
L4-5	1P-15	HEATER	1
L4-6	1P-20	CONTACTOR/RECEPT	1.6
TOTAL AMPS			22.68

PANEL BOARD SCHEDULE			
EXISTING DISTRIBUTION PANEL - "L5"			
SWITCH STATIONS: #6, #16, & "L5"			
MAIN LUG: 100AMP			
CIR.	BREAKER POLE/AMPS	FIXTURE QUANTITY	AMPS
L5-1	1P-20	2 - -	1.1
L5-2	1P-20	7 - -	3.9
L5-3	1P-20	- - -	-
L5-4	1P-20	5 - -	2.8
L5-5	1P-15	HEATER	1
L5-6	1P-20	CONTACTOR/RECEPT	1.6
TOTAL AMPS			10.4

PANEL BOARD SCHEDULE			
EXISTING LOAD CENTER - "1P"			
SWITCH STATIONS: NONE			
MAIN BREAKER: 200AMP			
CIR.	BREAKER POLE/AMPS	FEEDER	AMPS
1P-1	2P-60	PANEL - 1P1	6.6
1P-2	2P-60	PANEL - 1P2 & 1P2A	35.7
1P-3	2P-60	PANEL - 1P3	22.1
1P-4	2P-60	PANEL - 1P5	16.2
1P-5	1P-15	HEATER	1
1P-6	1P-20	NEW GFCI RECEPTACLE	1.6
TOTAL AMPS			83.2

PANEL BOARD SCHEDULE			
EXISTING DISTRIBUTION PANEL - "1P1"			
SWITCH STATIONS: #13, #14 & "1P1"			
MAIN BREAKER: 100AMP			
CIR.	BREAKER POLE/AMPS	FIXTURE QUANTITY	AMPS
1P1-1	1P-20	- 10 1	1.0
1P1-2	1P-20	- 4 2	.75
1P1-3	1P-20	3 7 -	2.2
1P1-4	1P-20	- - -	-
1P1-5	1P-15	HEATER	1
1P1-6	1P-20	CONTACTOR/RECEPT	1.6
TOTAL AMPS			6.55

PANEL BOARD SCHEDULE			
EXISTING DISTRIBUTION PANEL - "1P2"			
SWITCH STATIONS: #3, #4, #15, #17 & "1P2"			
MAIN BREAKER: 100AMP			
CIR.	BREAKER POLE/AMPS	FIXTURE QUANTITY	AMPS
1P2-1	1P-20	7 14 1	7.0
1P2-2	1P-20	4 7 7	4.3
1P2-3	1P-20	4 4 12	5.0
1P2-4	1P-20	6 4 4	4.5
1P2-5	1P-15	HEATER	1
1P2-6	1P-20	CONTACTOR/RECEPT	1.6
TOTAL AMPS			23.4

PANEL BOARD SCHEDULE			
EXISTING DISTRIBUTION PANEL - "1P2A"			
SWITCH STATIONS: #1 & #2 TUMBLERS			
MAIN BREAKER: 100AMP			
CIR.	BREAKER POLE/AMPS	FIXTURE QUANTITY	AMPS
1P2A-1	1P-20	10 6 2	9.7
1P2A-2	1P-20	- - -	-
1P2A-3	1P-20	- - -	-
1P2A-4	-----	- - -	-
1P2A-5	1P-15	HEATER	1
1P2A-6	1P-20	CONTACTOR/RECEPT	1.6
TOTAL AMPS			12.3

PANEL BOARD SCHEDULE			
EXISTING DISTRIBUTION PANEL - "1P3"			
SWITCH STATIONS: #21, #25 & "1P3"			
MAIN BREAKER: 100AMP			
CIR.	BREAKER POLE/AMPS	FIXTURE QUANTITY	AMPS
1P3-1	1P-20	9 1 5	6.1
1P3-2	1P-20	7 5 2	4.7
1P3-3	1P-20	15 - 2	8.7
1P3-4	1P-20	- - -	-
1P3-5	1P-15	HEATER	1
1P3-6	1P-20	CONTACTOR/RECEPT	1.6
TOTAL AMPS			22.1

PANEL BOARD SCHEDULE			
EXISTING DISTRIBUTION PANEL - "1P5"			
SWITCH STATIONS: #18, #19 & "1P5"			
MAIN BREAKER: 100AMP			
CIR.	BREAKER POLE/AMPS	FIXTURE QUANTITY	AMPS
1P5-1	1P-20	4 3 2	2.9
1P5-2	1P-20	4 3 2	2.9
1P5-3	1P-20	6 1 -	3.4
1P5-4	1P-20	6 - 5	4.4
1P5-5	1P-15	HEATER	1
1P5-6	1P-20	CONTACTOR/RECEPT	1.6
TOTAL AMPS			16.2

PANEL BOARD SCHEDULE			
EXISTING LOAD CENTER - "2P"			
SWITCH STATIONS: NONE			
MAIN BREAKER: 2P-100			
CIR.	BREAKER POLE/AMPS	FEEDER	AMPS
2P-1	2P-60	PANEL - "2P1"	14.1
2P-2	2P-60	PANEL - "2P2"	15.4
2P-3	2P-60	PANEL - "2P3"	6.25
2P-4	1P-20	SPARE	-
2P-5	1P-15	HEATER	1
2P-6	1P-20	CONTACTOR/RECEPT	1.6
TOTAL AMPS			38.4

PANEL BOARD SCHEDULE			
EXISTING DISTRIBUTION PANEL - "2P1"			
SWITCH STATIONS: #20, #20a & #20b			
MAIN BREAKER: 100AMP			
CIR.	BREAKER POLE/AMPS	FIXTURE QUANTITY	AMPS
2P1-1	1P-20	8 5 2	5.3
2P1-2	1P-20	8 7 -	5.0
2P1-3	1P-20	2 1 -	1.2
2P1-4	1P-20	- - -	-
2P1-5	1P-15	HEATER	1
2P1-6	1P-20	CONTACTOR/RECEPT	1.6
TOTAL AMPS			14.1

PANEL BOARD SCHEDULE			
EXISTING DISTRIBUTION PANEL - "2P2"			
SWITCH STATIONS: #22, #24 & "2P2"			
MAIN BREAKER: 100AMP			
CIR.	BREAKER POLE/AMPS	FIXTURE QUANTITY	AMPS
2P2-1	1P-20	7 18 5	6.4
2P2-2	1P-20	- 16 1	1.6
2P2-3	1P-20	4 17 -	3.7
2P2-4	1P-20	- 14 4	1.1
2P2-5	1P-15	HEATER	1
2P2-6	1P-20	CONTACTOR/RECEPT	1.6
TOTAL AMPS			15.4


PANEL BOARD SCHEDULE			
EXISTING DISTRIBUTION PANEL - "2P3"			
SWITCH STATIONS: #26, #27, #28 & #29 TUMBLER			
MAIN BREAKER: 100AMP			
CIR.	BREAKER POLE/AMPS	FIXTURE QUANTITY	AMPS
2P3-1	1P-20	1 - -	.56
2P3-2	1P-20	1 - -	.56
2P3-3	1P-20	- - 8	1.7
2P3-4	1P-20	- - 4	.83
2P3-5	1P-15	HEATER	1
2P3-6	1P-20	NEW GFCI RECEPTACLE	1.6
TOTAL AMPS			6.25

GENERAL NOTES:

- ALL PANELS RECEPTACLES IS GETTING REPLACED WITH NEW GFCI RECEPTACLES.



GRW PROJECT NO. 4495-25
 CLIENT PROJECT NO. XXXX
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PANEL BOARD SCHEDULES
 WYANDOTTE CAVE (LARGE)
 LEAVENWORTH, INDIANA

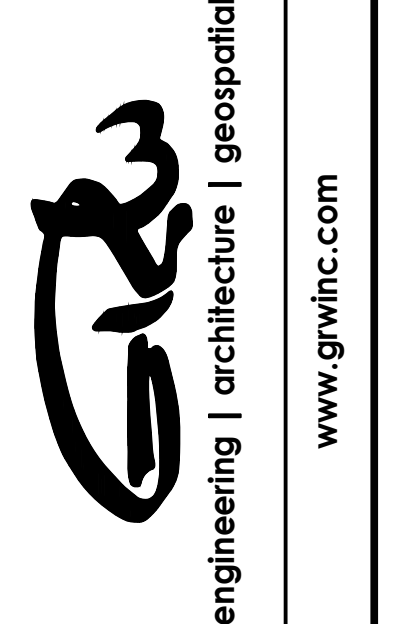DESIGNED	DRC
DRAWN	RHR
REVIEWED	WLM
APPROVED	WLM

NO.	DATE	DESCRIPTION

SCALE CHECK: _____ THIS MARK SHOULD MEASURE EXACTLY 1" WHEN PLOTTED

DATE: SEPTEMBER 2018
 SCALE: NOT TO SCALE
 SHEET NO.

E-602