# DEPARTMENT OF NATURAL RESOURCES WYANDOTTE CAVE (LARGE)

# CITY OF LEAVENWORTH, INDIANA







#### INDEX OF DRAWINGS

#### DWG. No.

C 000 COV

101 WYANDOTTE CAVE - OVERALL KEY PLAN

01 WYANDOTTE CAVE - ENTRANCE OF CAVE DEMOLITION

E-402 WIANDOTTE CAVE - MIDDEE OF CAVE DEMOCITIC

E-403 WYANDOTTE CAVE - END OF CAVE DEMOLITION

E-404 WYANDOTTE CAVE - ENTRANCE OF CAVE NEW WOR

E-405 WYANDOTTE CAVE - MIDDLE OF CAVE NEW WORK

E-406 WYANDOTTE CAVE - END OF CAVE NEW W

E-407 WYANDOTTE CAVE - VISITOR CENTER

E-408 WYANDOTTE CAVE - SEISMOGRAPH BUILDING

E-501 ELECTRICAL DETAILS I

-502 ELECTRICAL DETAILS II

E-601 ELECTRICAL ONELINES AND SCHEDULES

75% DESIGN

GRW PROJECT NO. 4495-25

### **GENERAL NOTES:**

1. THE PARK STAFF HAVE SPENT A LOT OF TIME AND MONEY TO MAKE ARTIFICAL SHROUDS, COVERS, GROUTING, STACKING ROCKS AND OTHER EFFORTS TO CONCEAL THE ELECTRICAL WORK AND HAVE THE CAVE APPEAR IN ITS NATURAL STATE AS MUCH AS POSSIBLE. THE WORK OF THIS CONTRACT SHALL PRESERVE AS MUCH OF THEIR EFFORTS AS POSSIBLE. PARK STAFF SHALL RECONCEAL THE ELECTRICAL WORK AFTER MODIFICATIONS ARE COMPLETED, AS LONG AS THE CONTRACTOR IS MAKING EFFORTS TO MINIMIZE THE DAMAGE TO EXISTING CONDITIONS.

WYANDOTTE CAVE

SCALE: 1"=60'-0"

0 60'
120'

CLIENT PROJECT NO. XXXX

CLIENT PROJECT NO. XXXX

ALL RIGHTS RESERVED:
THIS DOCUMENT IS THE PROPERTY OF
GRW ENGINEERS, INC. AND SHALL NOT
BE REPRODUCED IN WHOLE OR IN PART
OR USED FOR CONSTRUCTION OF
OTHER THAN THIS SPECIFIC PROJECT


engineering | architecture | geospati


WYANDOTTE CAVE OVERALL KEY PLAN
WYANDOTTE CAVE (LARGE)


DESCRIPTION
DESCRIPTION
DESCRIPTION
DESCRIPTION
DESCRIPTION
DEAWN:
REVIEWED:
WLM
WLM
THIS MARK SHOULD MEASURE EXACTLY 1" WHEN PLOTTED
WLM
WLM

DATE:
AUGUST 2018
SCALE:

1"=60'
SHEET NO.

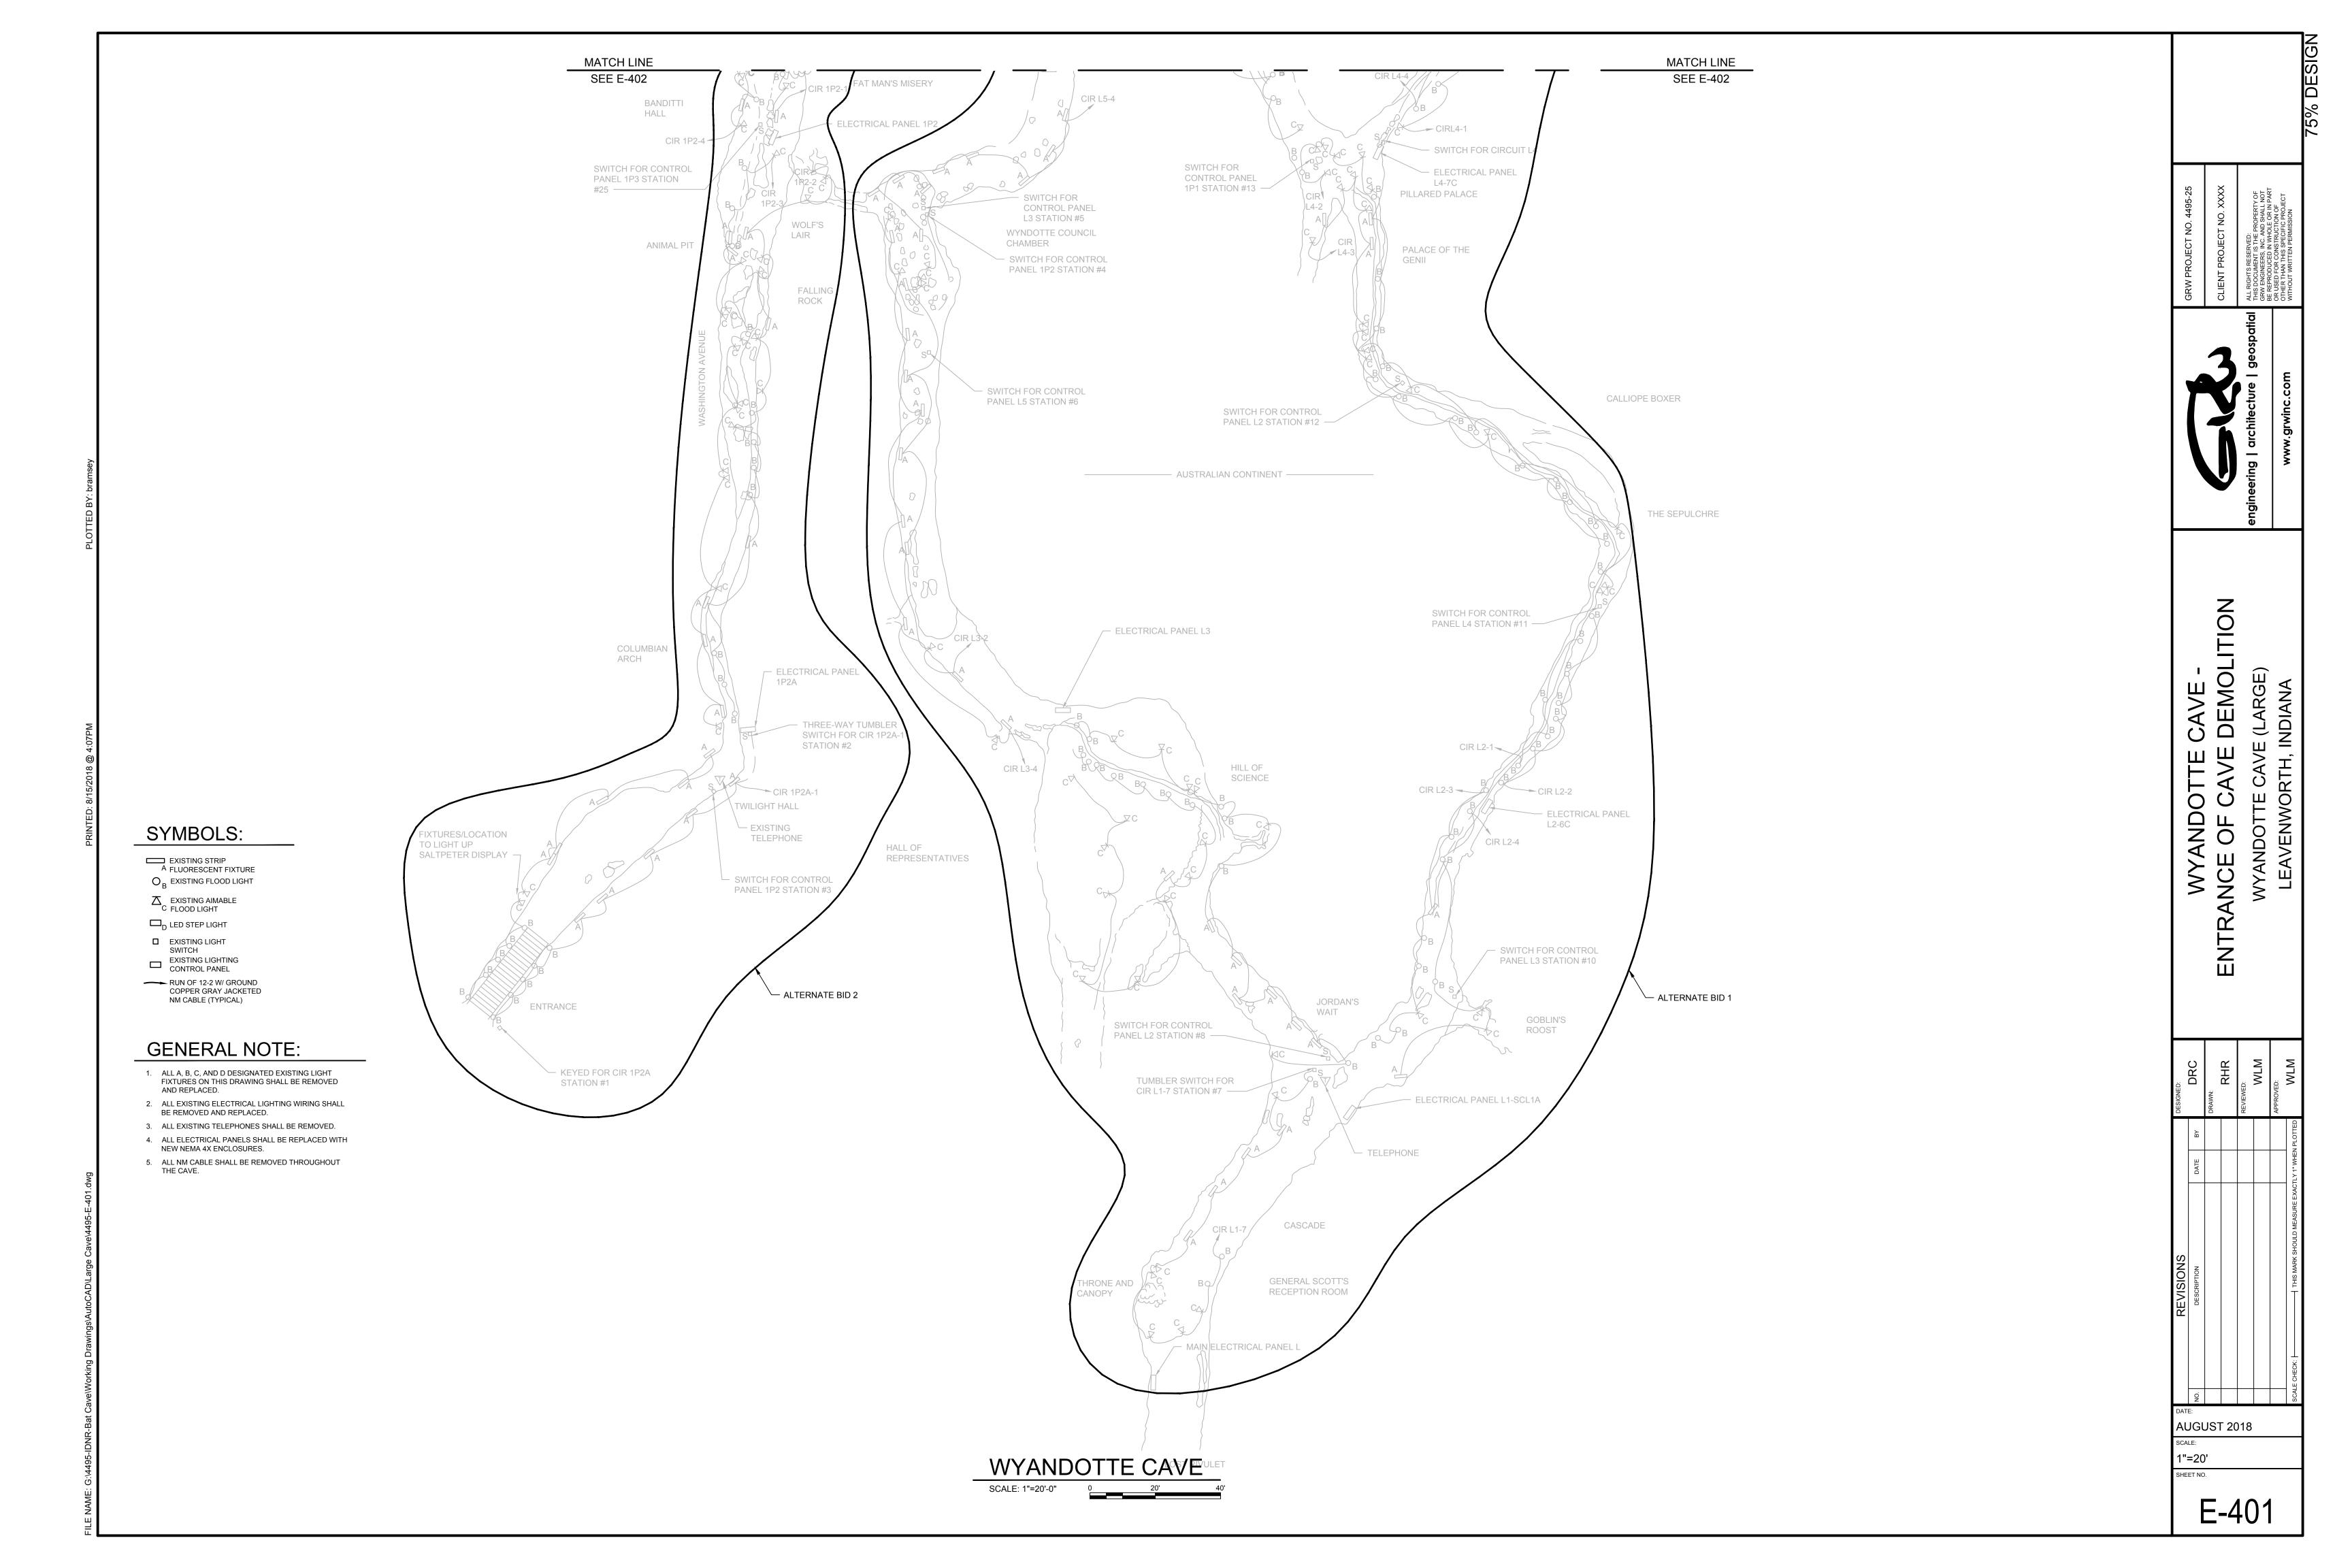

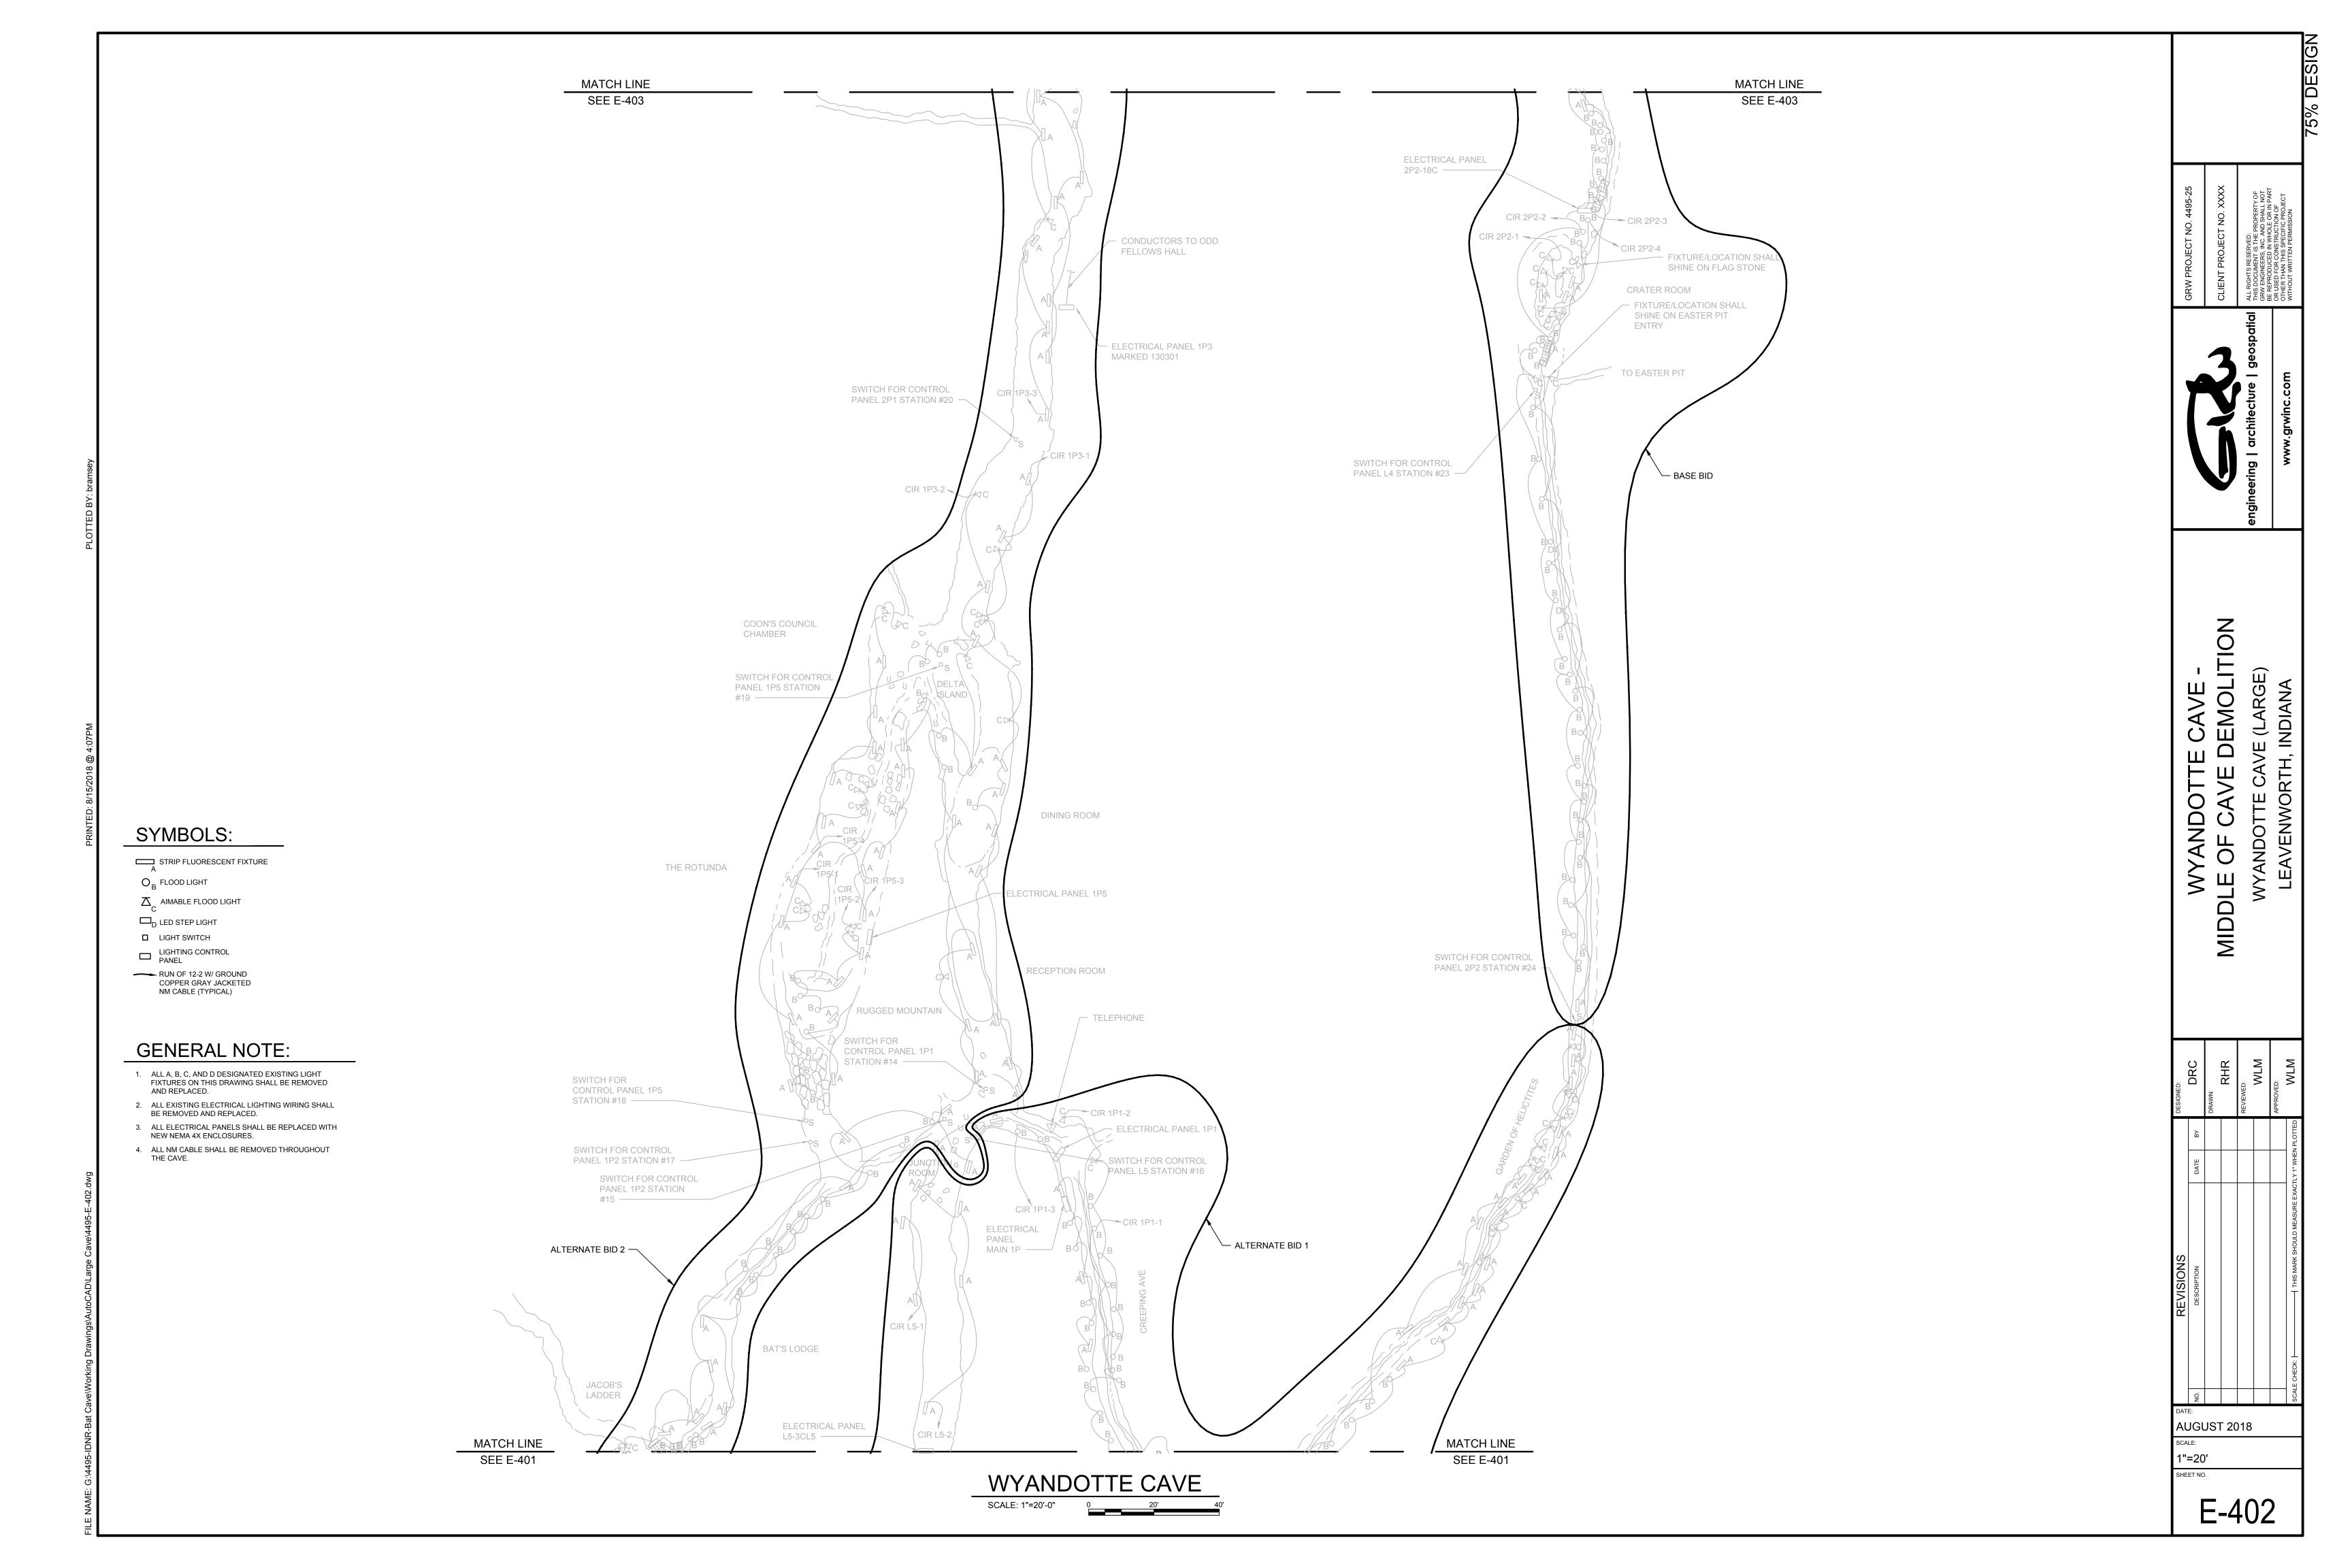

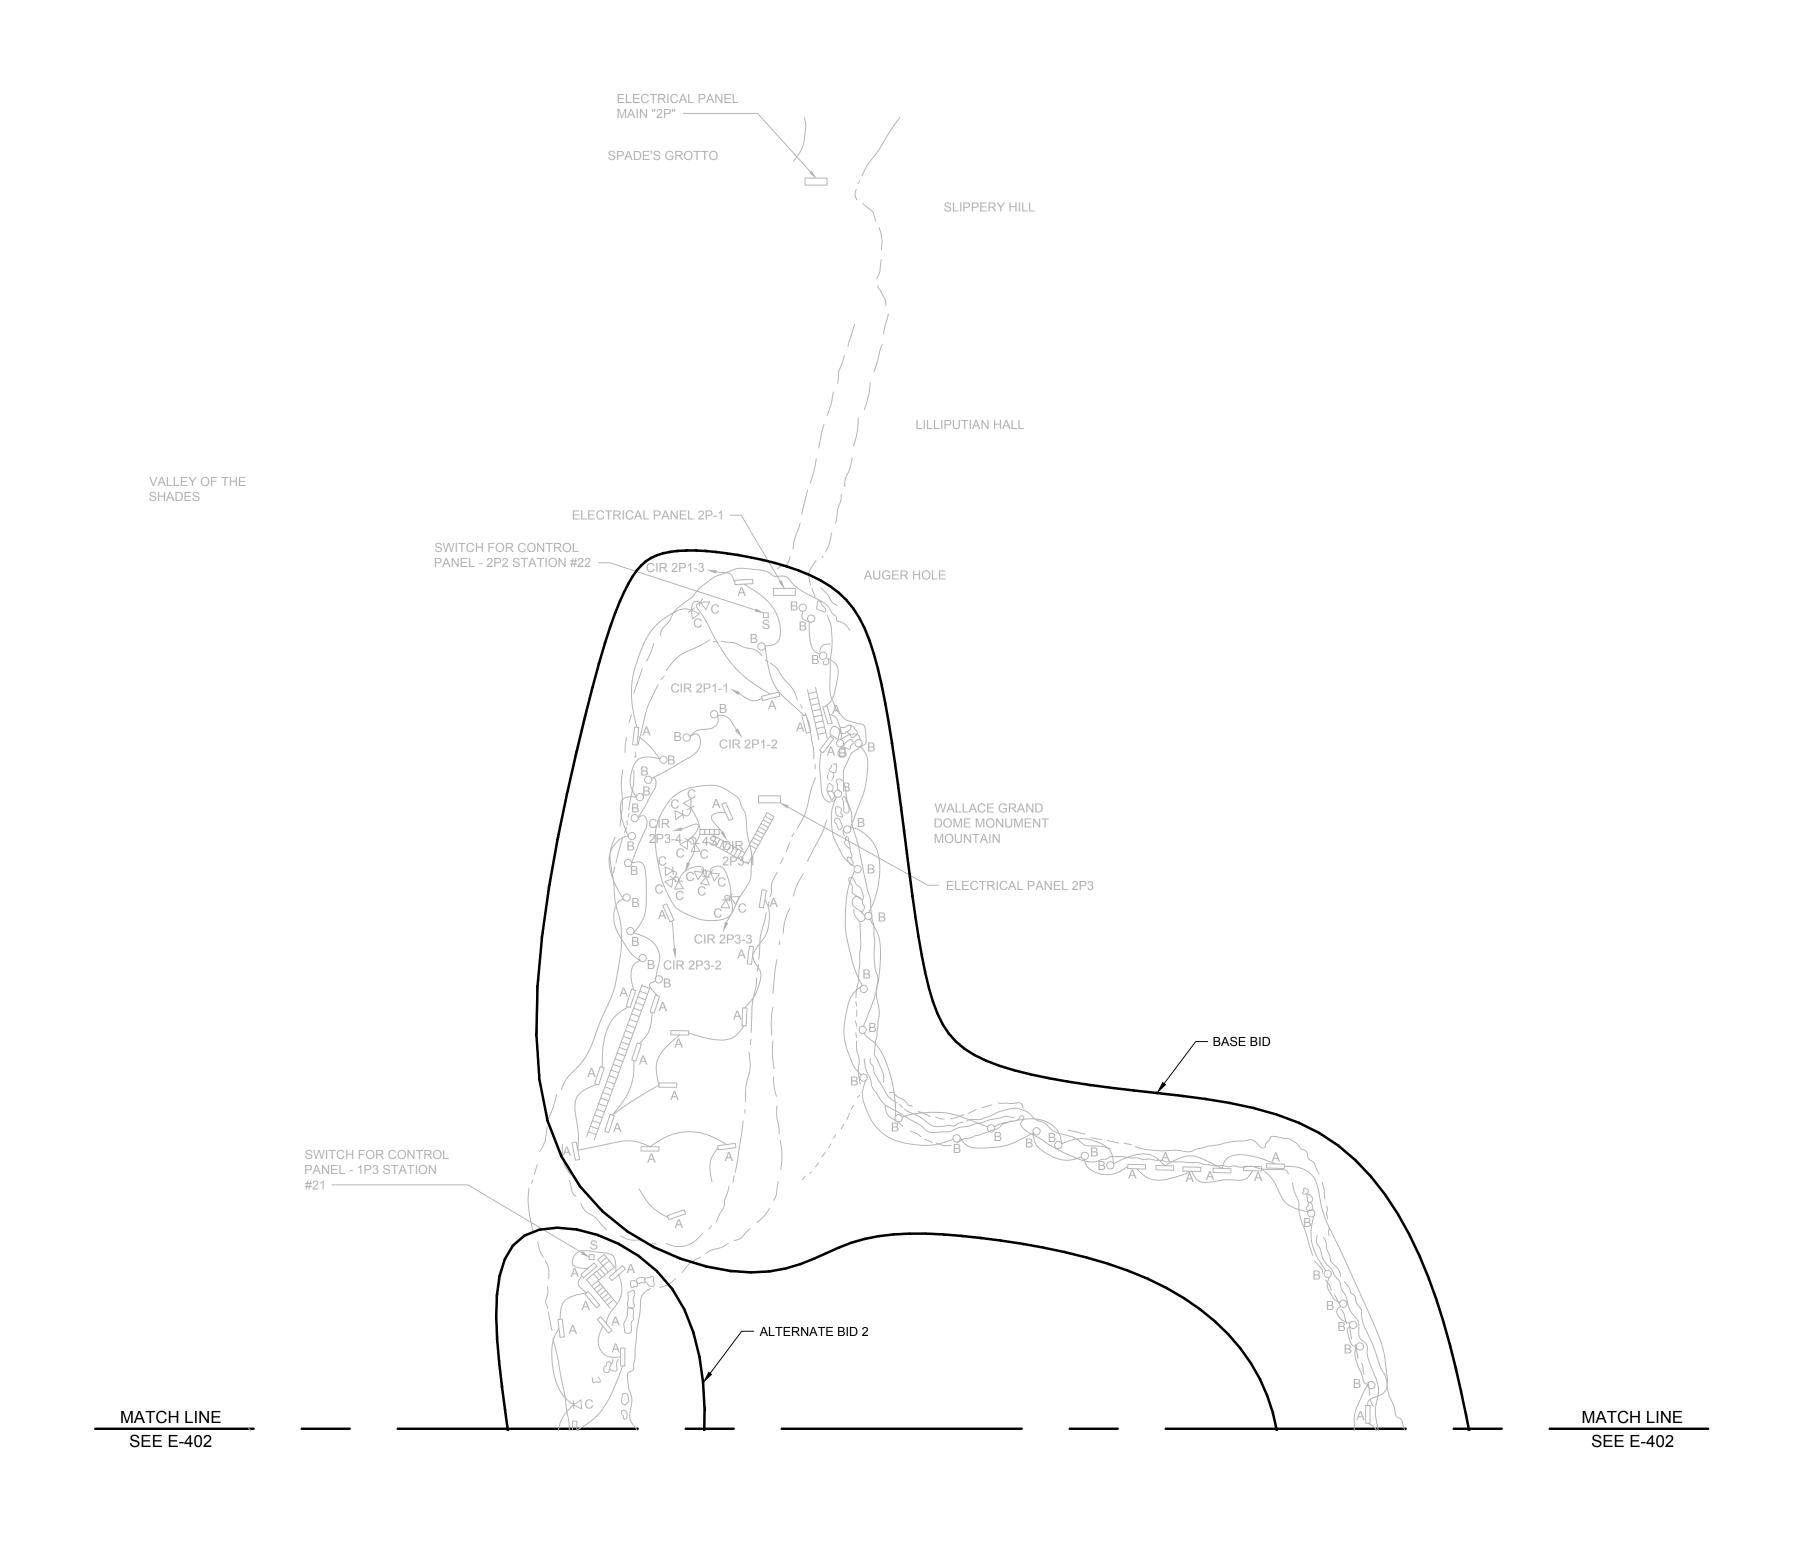

WYANDOTTE CAVE

SCALE: 1"=20'-0"

SYMBOLS:

 $oxedsymbol{oxed}_{ extsf{C}}$  AIMABLE FLOOD LIGHT

 $\mathsf{O}_\mathsf{B}$  FLOOD LIGHT

 $\square_{\mathsf{D}}$  LED STEP LIGHT □ LIGHT SWITCH

LIGHTING CONTROL PANEL

RUN OF 12-2 W/ GROUND COPPER GRAY JACKETED NM CABLE (TYPICAL)

**GENERAL NOTE:** 


ALL A, B, C, AND D DESIGNATED EXISTING LIGHT FIXTURES ON THIS DRAWING SHALL BE REMOVED AND REPLACED.

ALL EXISTING ELECTRICAL LIGHTING WIRING SHALL BE REMOVED AND REPLACED.

ALL ELECTRICAL PANELS SHALL BE REPLACED WITH NEW NEMA 4X ENCLOSURES.


4. ALL NM CABLE SHALL BE REMOVED THROUGHOUT THE CAVE.


STRIP FLUORESCENT FIXTURE

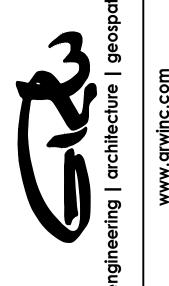


WYANDOT
LAST OF CAVE
WYANDOTTE C
LEAVENWORT

AUGUST 2018 1"=20'

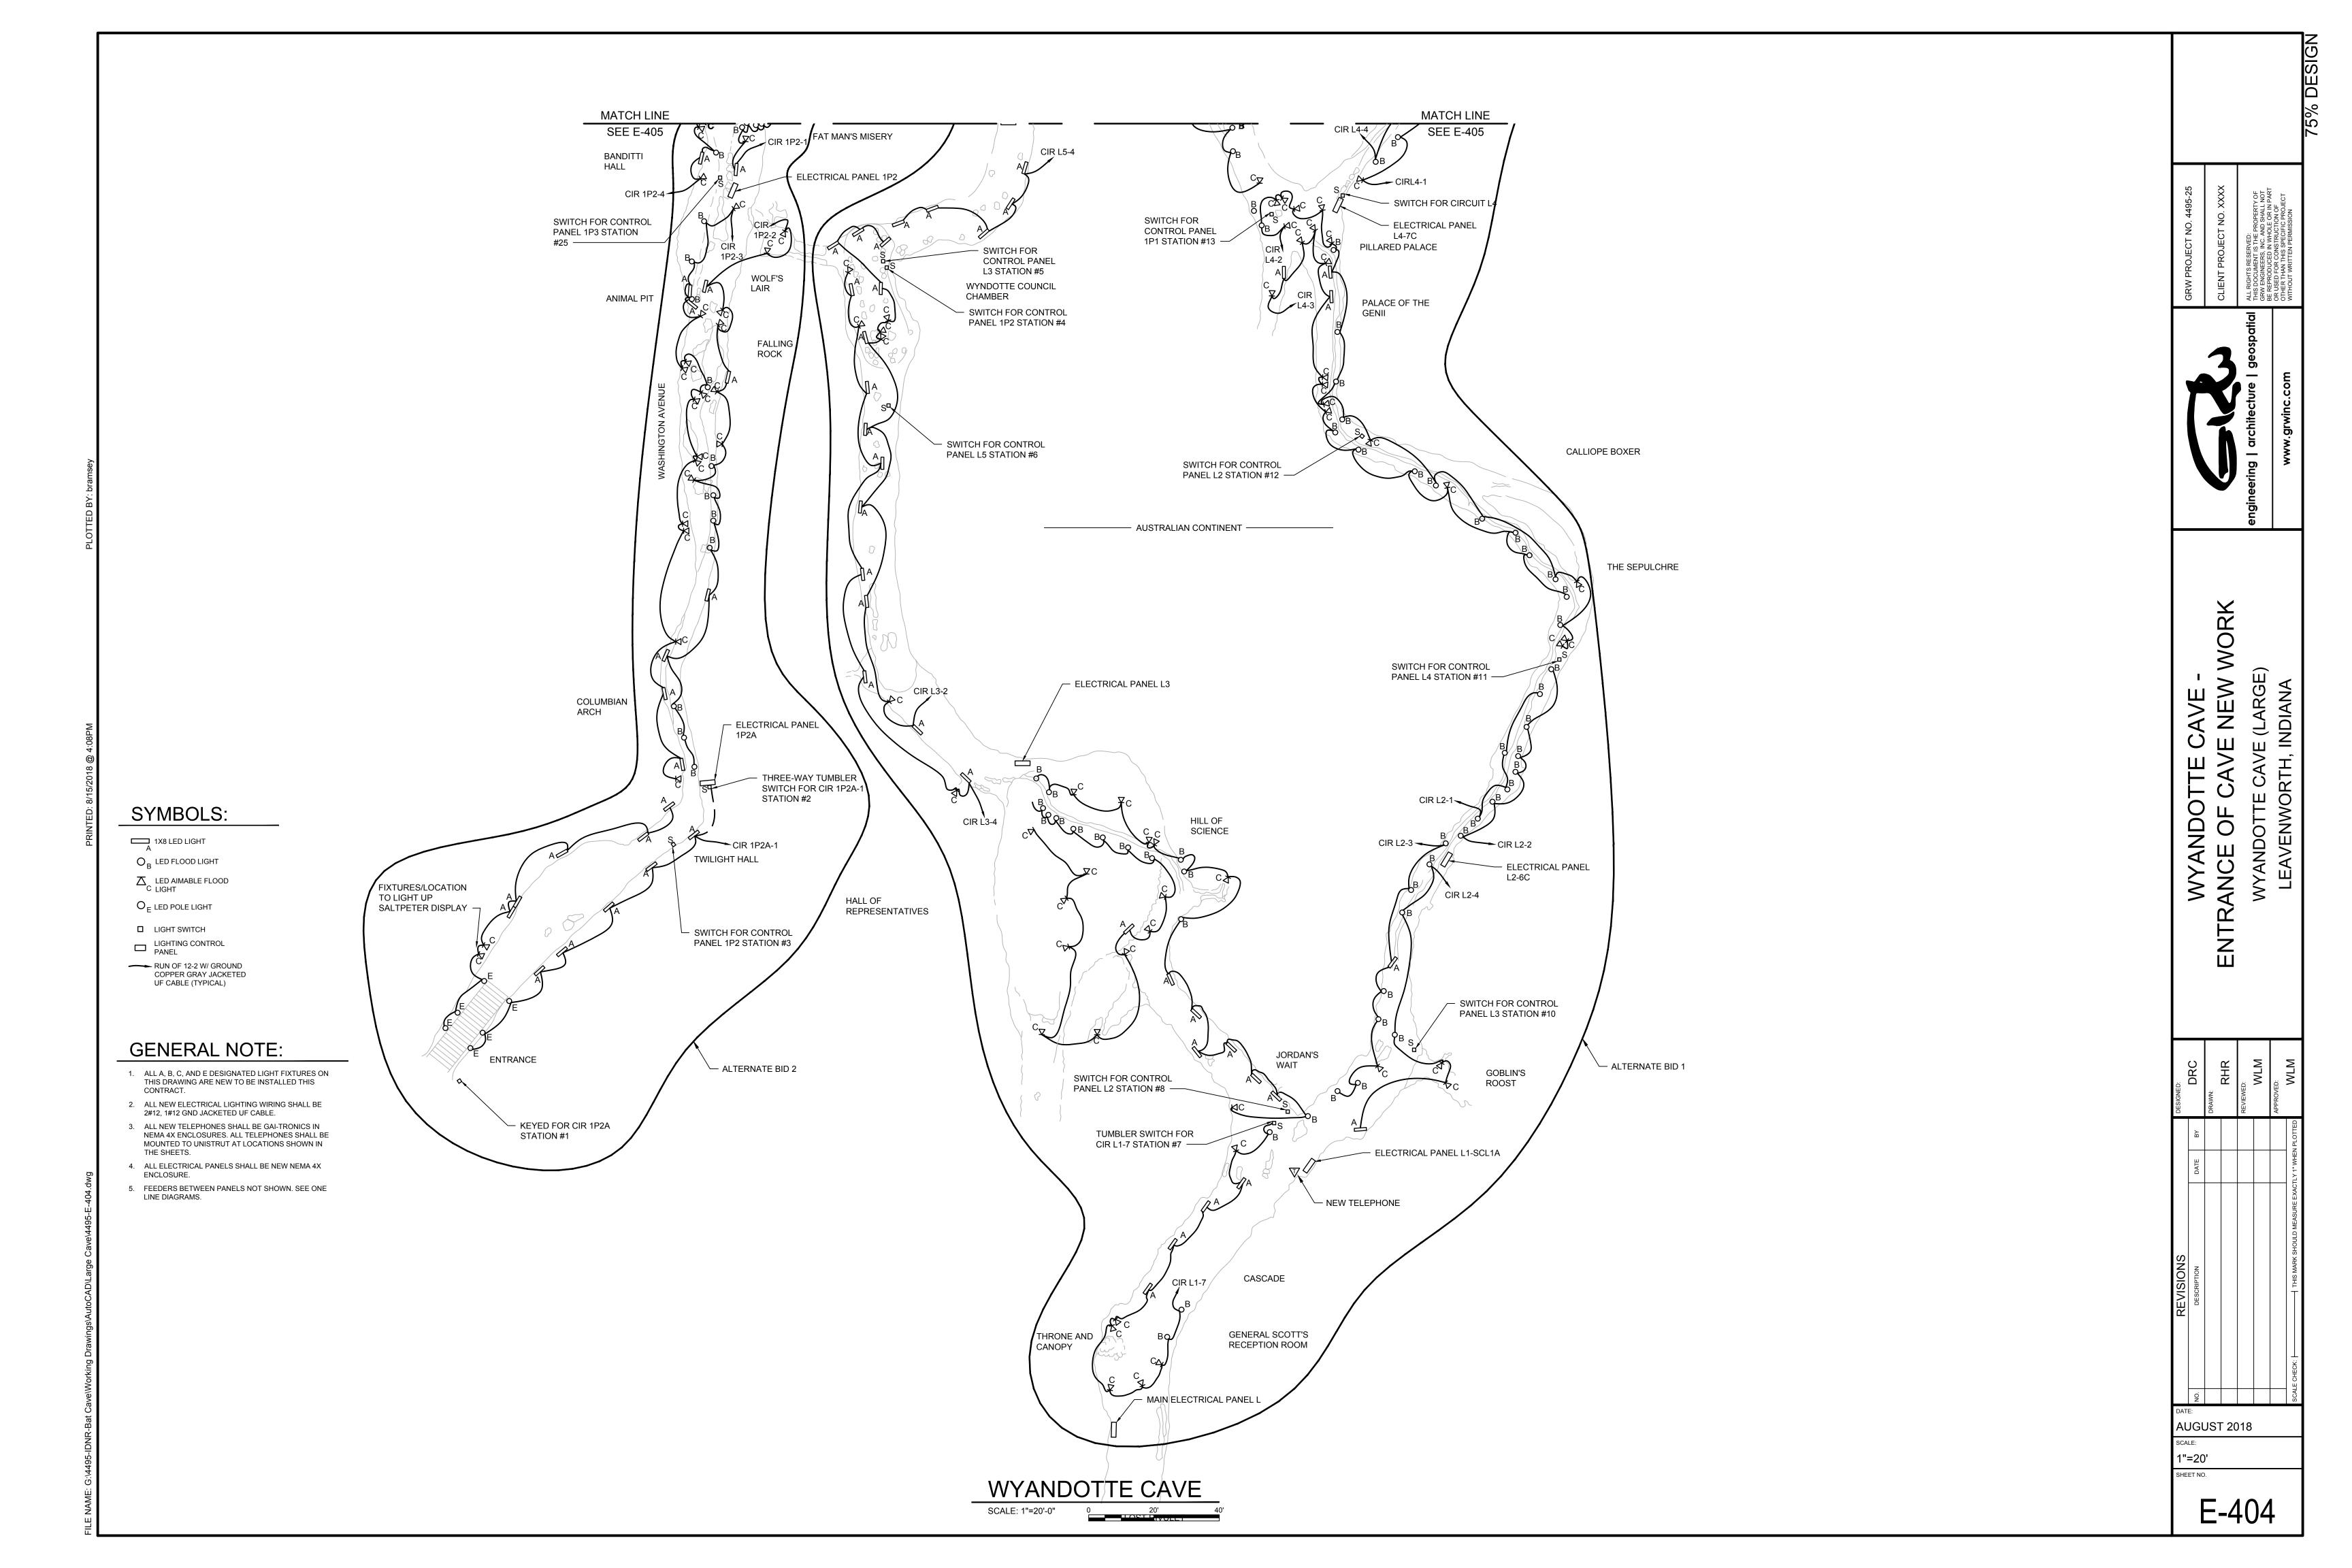

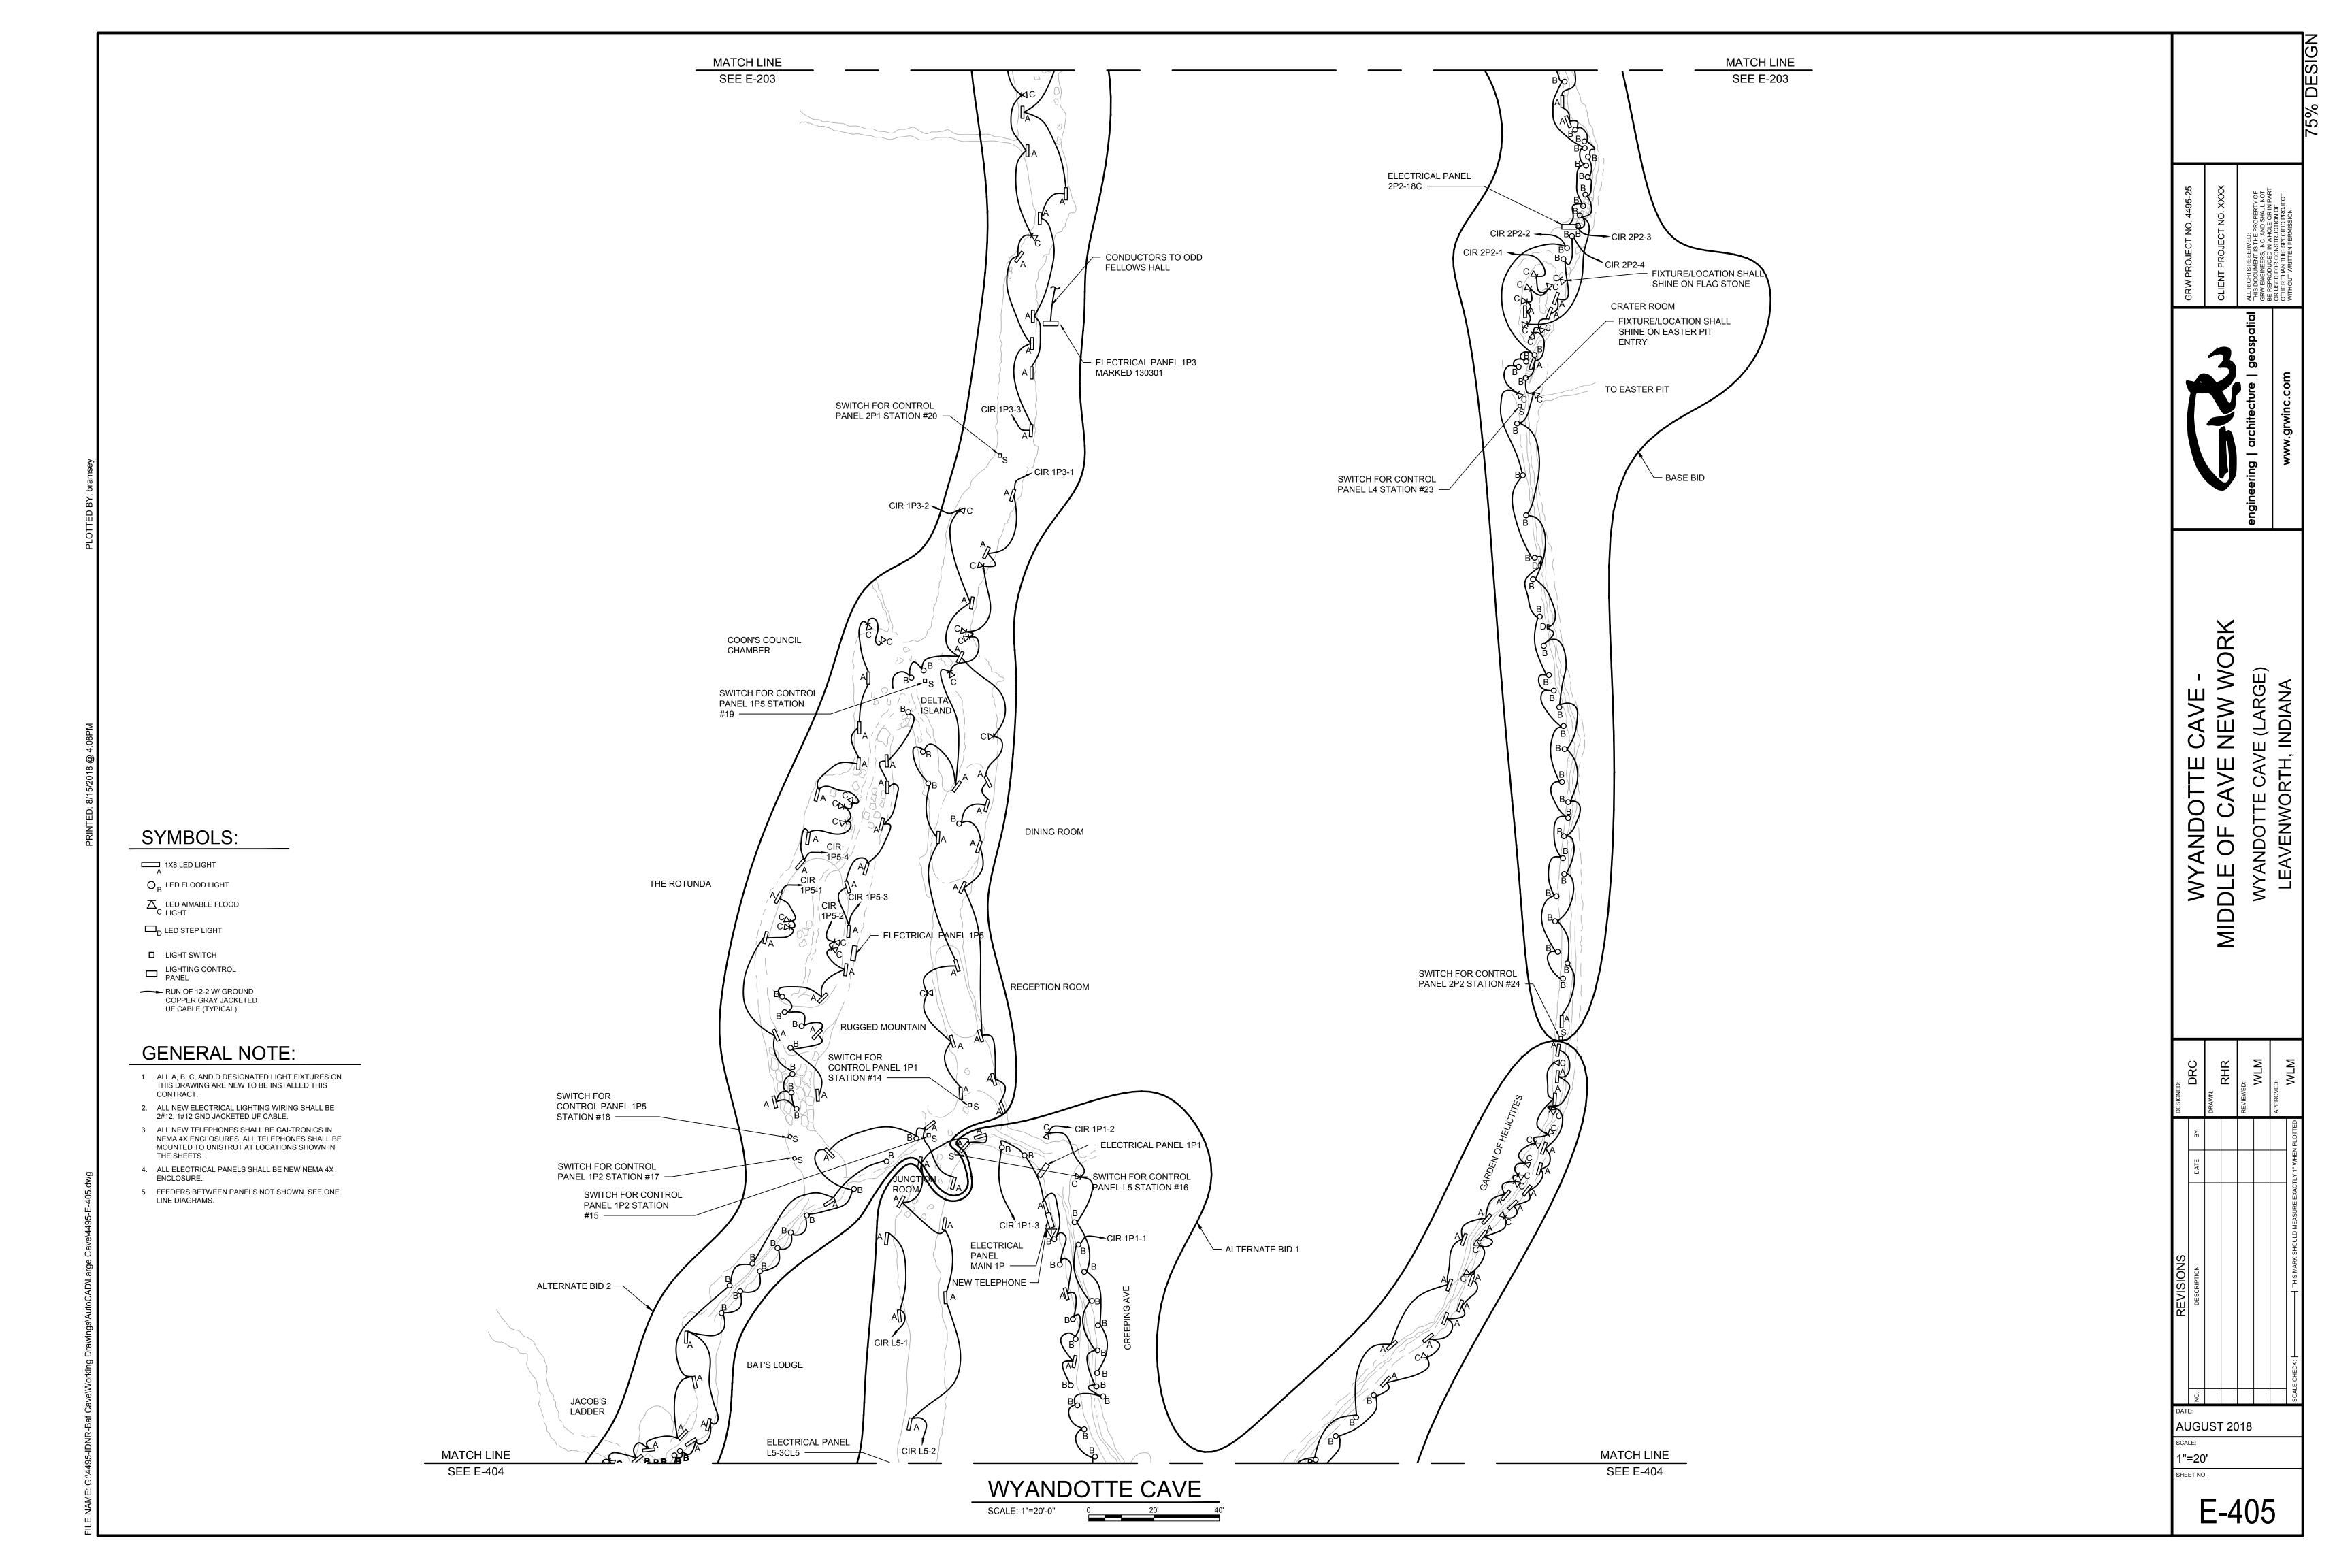

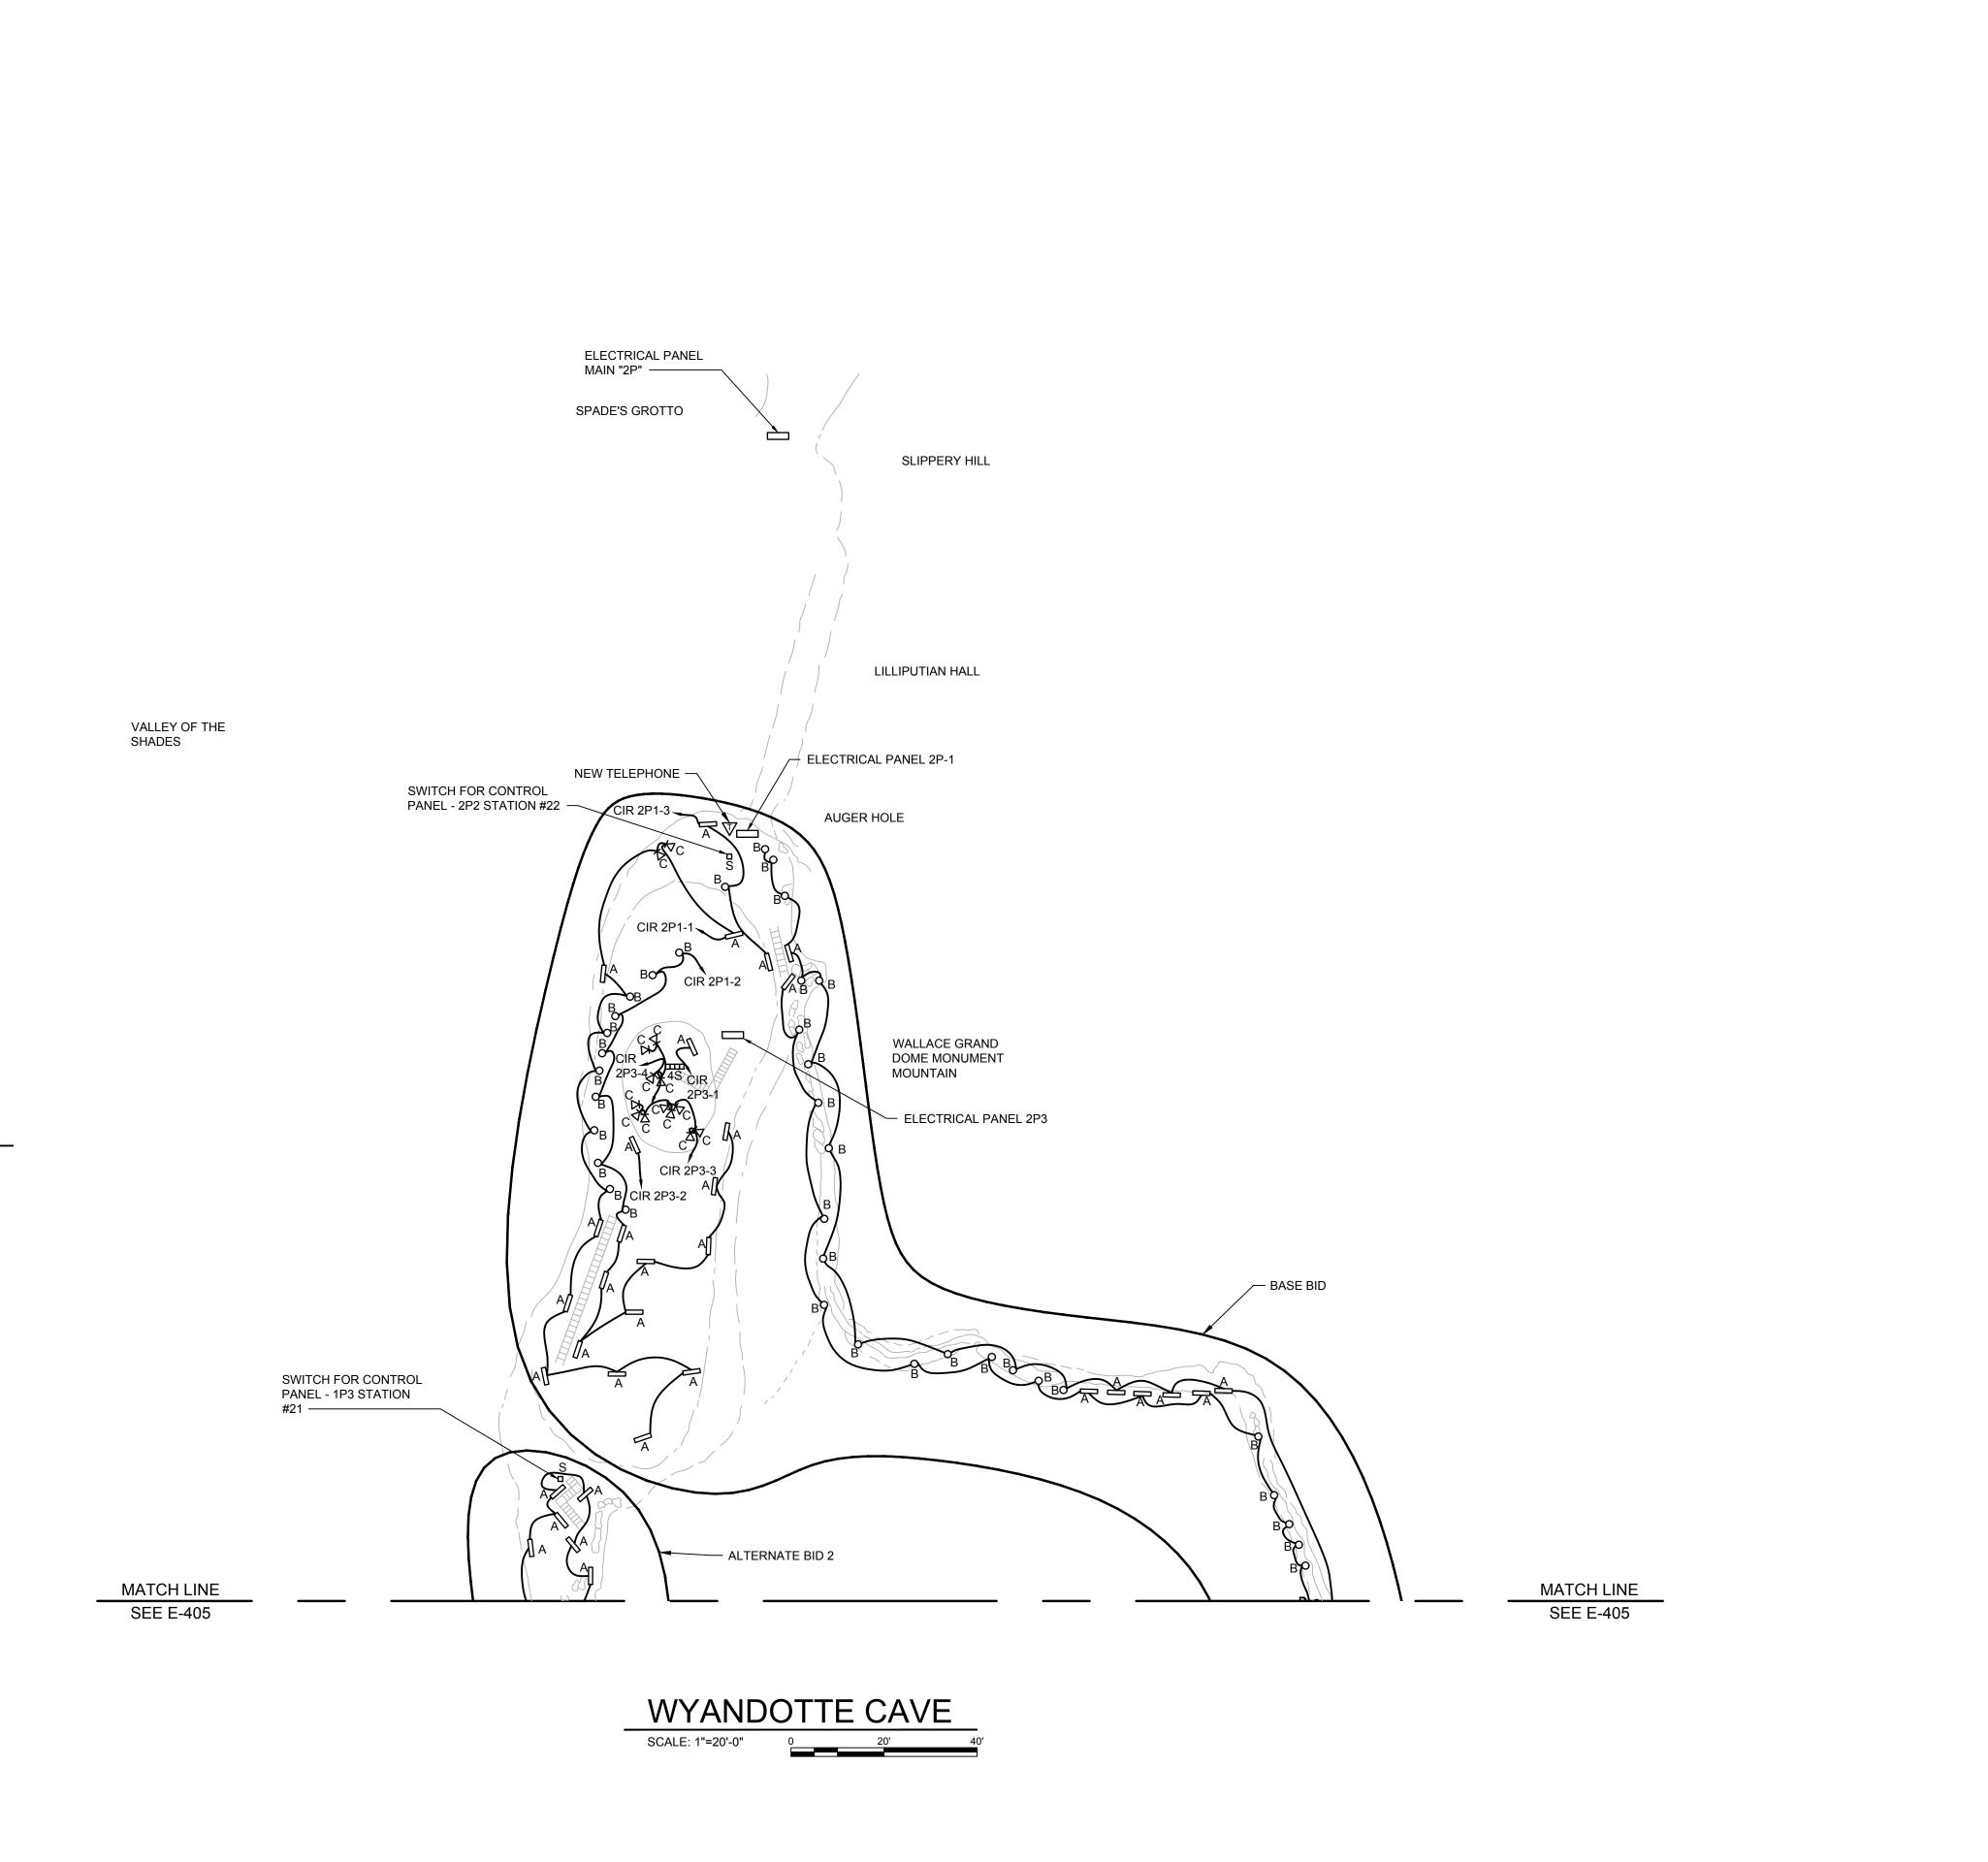

SYMBOLS:

 $\mathsf{O}_\mathsf{B}$  flood light

□ LIGHT SWITCH

CONTRACT.

ENCLOSURE.

A STRIP FLUORESCENT FIXTURE

 $\overline{\Delta}_{
m C}$  AIMABLE FLOOD LIGHT

LIGHTING CONTROL PANEL L-1, L-2, OR L-3

RUN OF 12-2 W/ GROUND COPPER GRAY JACKETED UF CABLE (TYPICAL)

# PICTURE NUMBER REFERENCE TO DRAWING E-102

GENERAL NOTE:

ALL A, B, AND C DESIGNATED LIGHT FIXTURES ON THIS DRAWING ARE NEW TO BE INSTALLED THIS

 ALL NEW ELECTRICAL LIGHTING WIRING SHALL BE 2#12, 1#12 GND JACKETED UF CABLE.

 ALL NEW TELEPHONES SHALL BE GAI-TRONICS IN NEMA 4X ENCLOSURES. ALL TELEPHONES SHALL BE MOUNTED TO UNISTRUT AT LOCATIONS SHOWN IN

4. ALL ELECTRICAL PANELS SHALL BE NEW NEMA 4X

FEEDERS BETWEEN PANELS NOT SHOWN. SEE ONE LINE DIAGRAMS. ATY OF LL NOT IN PART DF JJECT

CLIENT PROJECT NO. XXXX

ALL RIGHTS RESERVED:
THIS DOCUMENT IS THE PROPERTY OF
GRW ENGINEERS, INC. AND SHALL NOT

gineering | architecture | geospati

WYANDOTTE CAVE

ND OF CAV NEW WORK

WYANDOTTE CAVE (LARGE)

PRAWN:

REVIEWED:

WLM

THIS MARK SHOULD MEASURE EXACTLY 1" WHEN PLOTTED


WLM


WLM


WLM

WLM


DATE:
AUGUST 2018
SCALE:
1"=20'

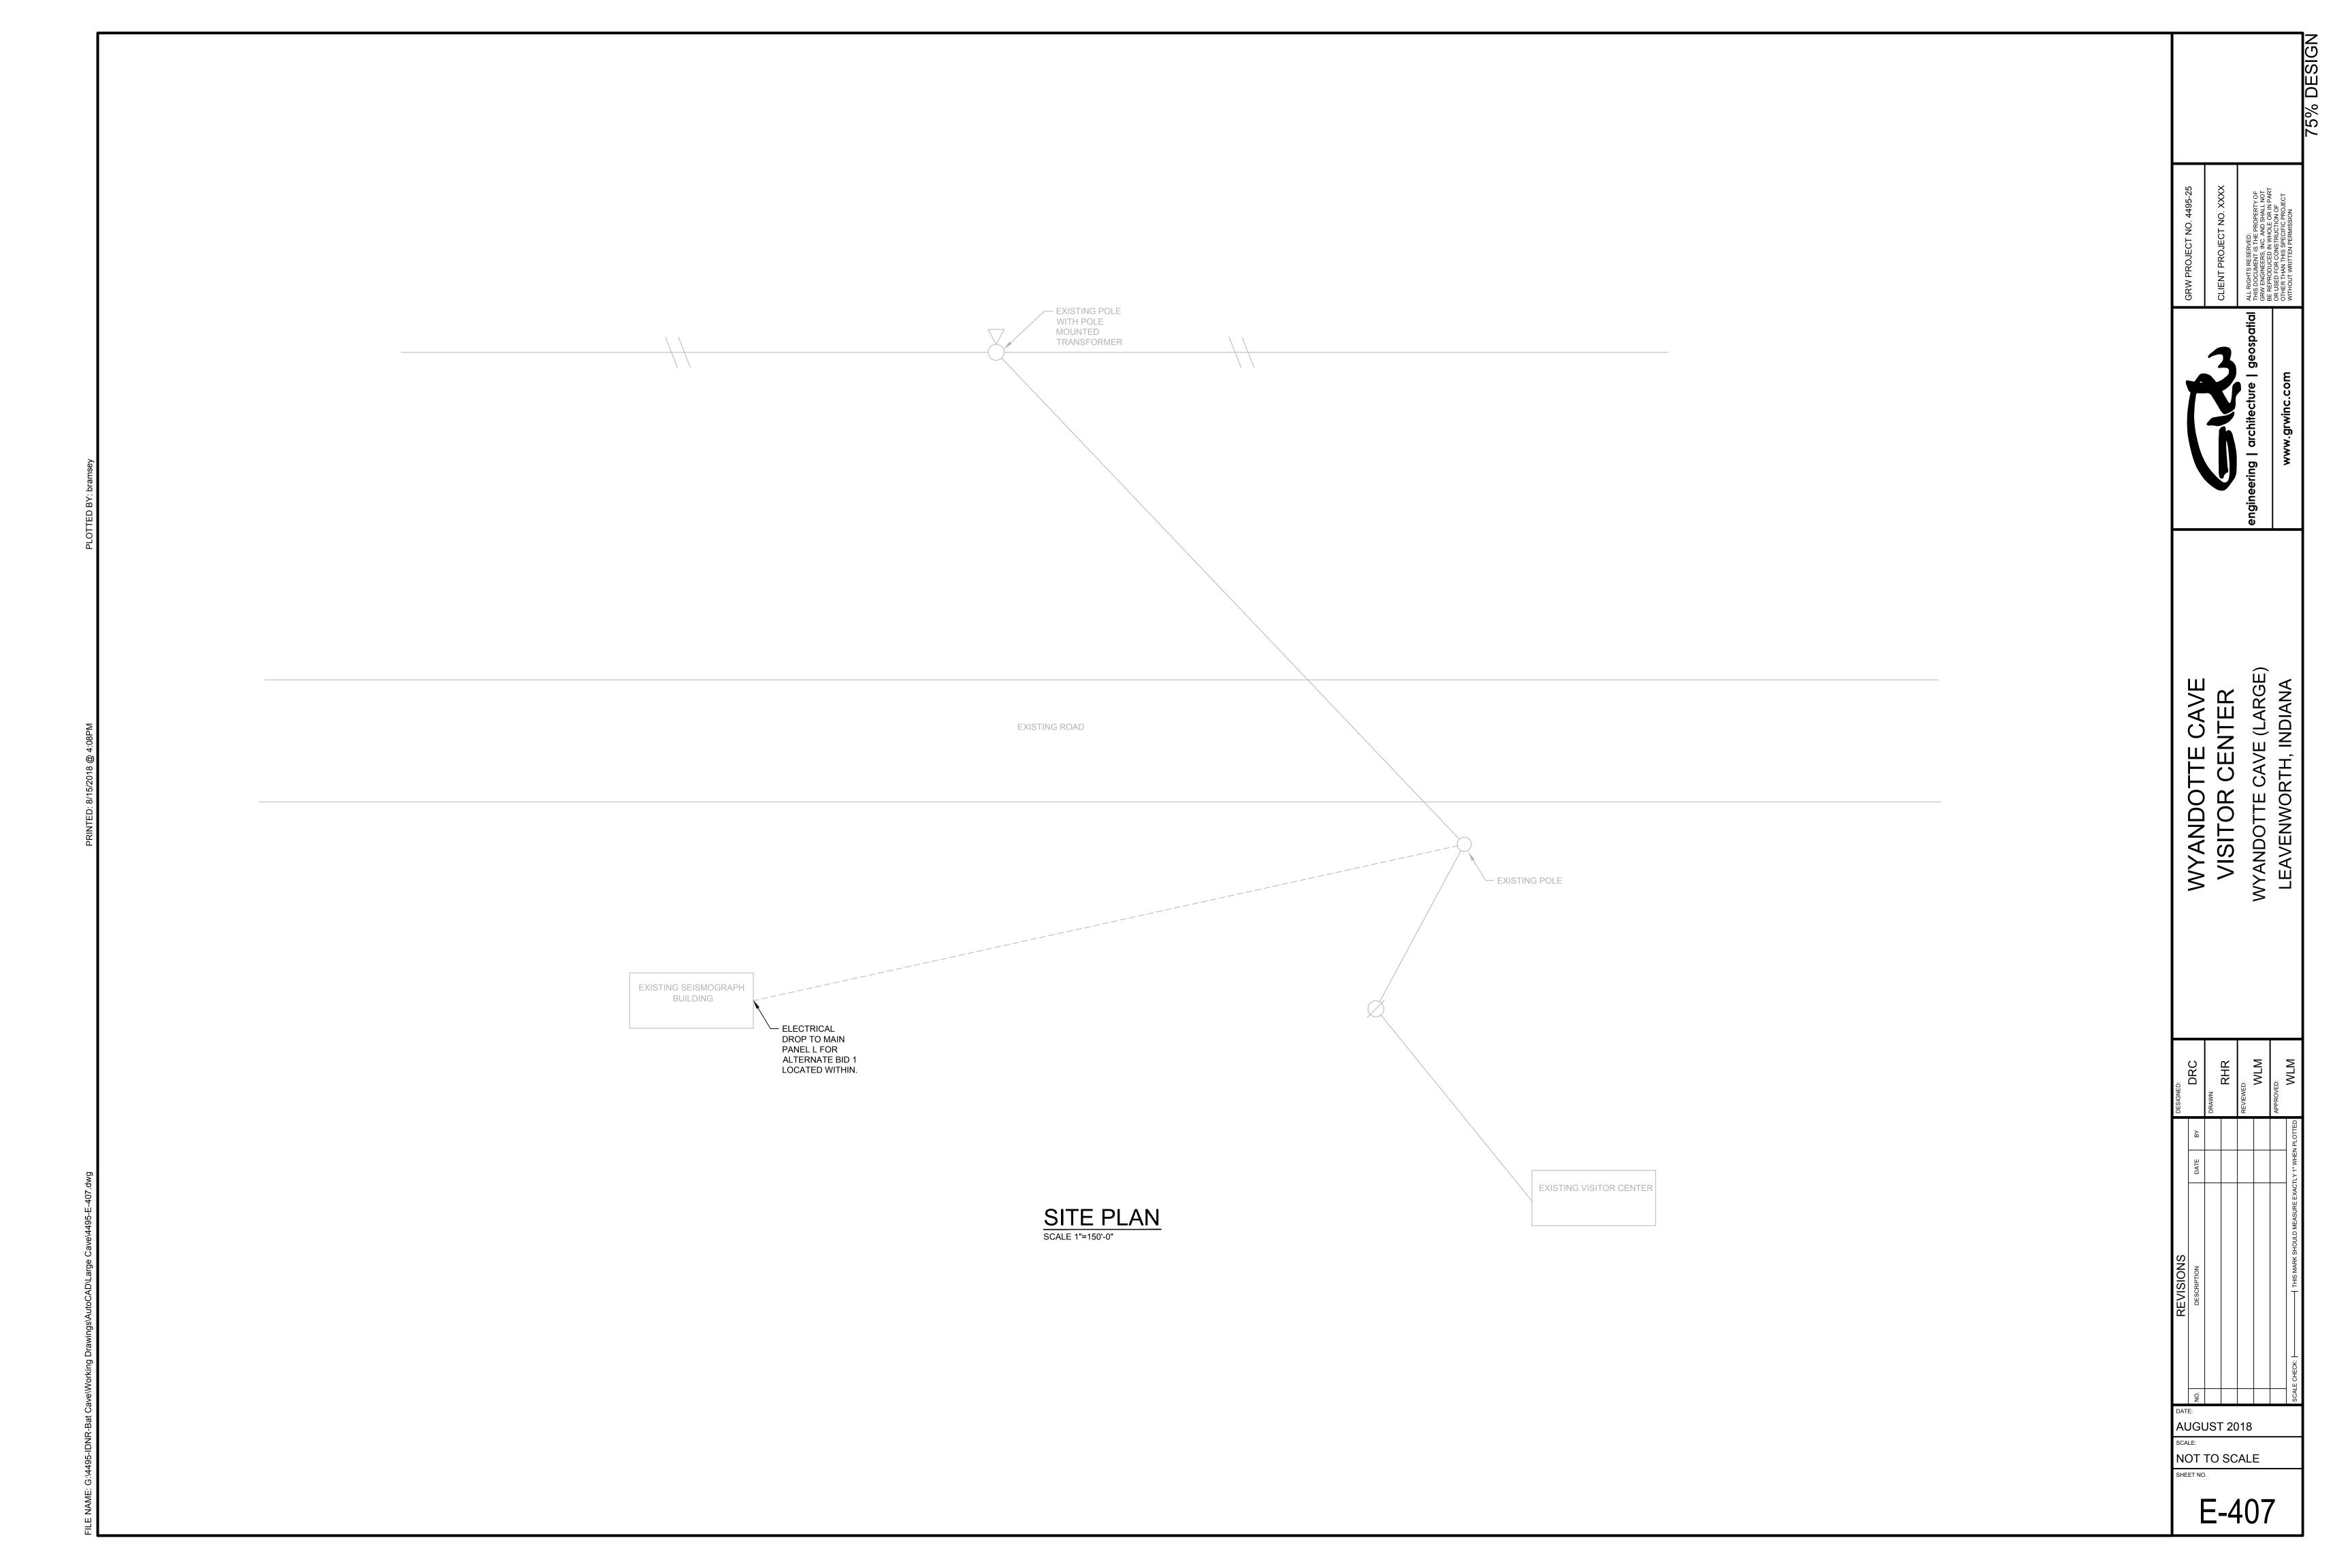

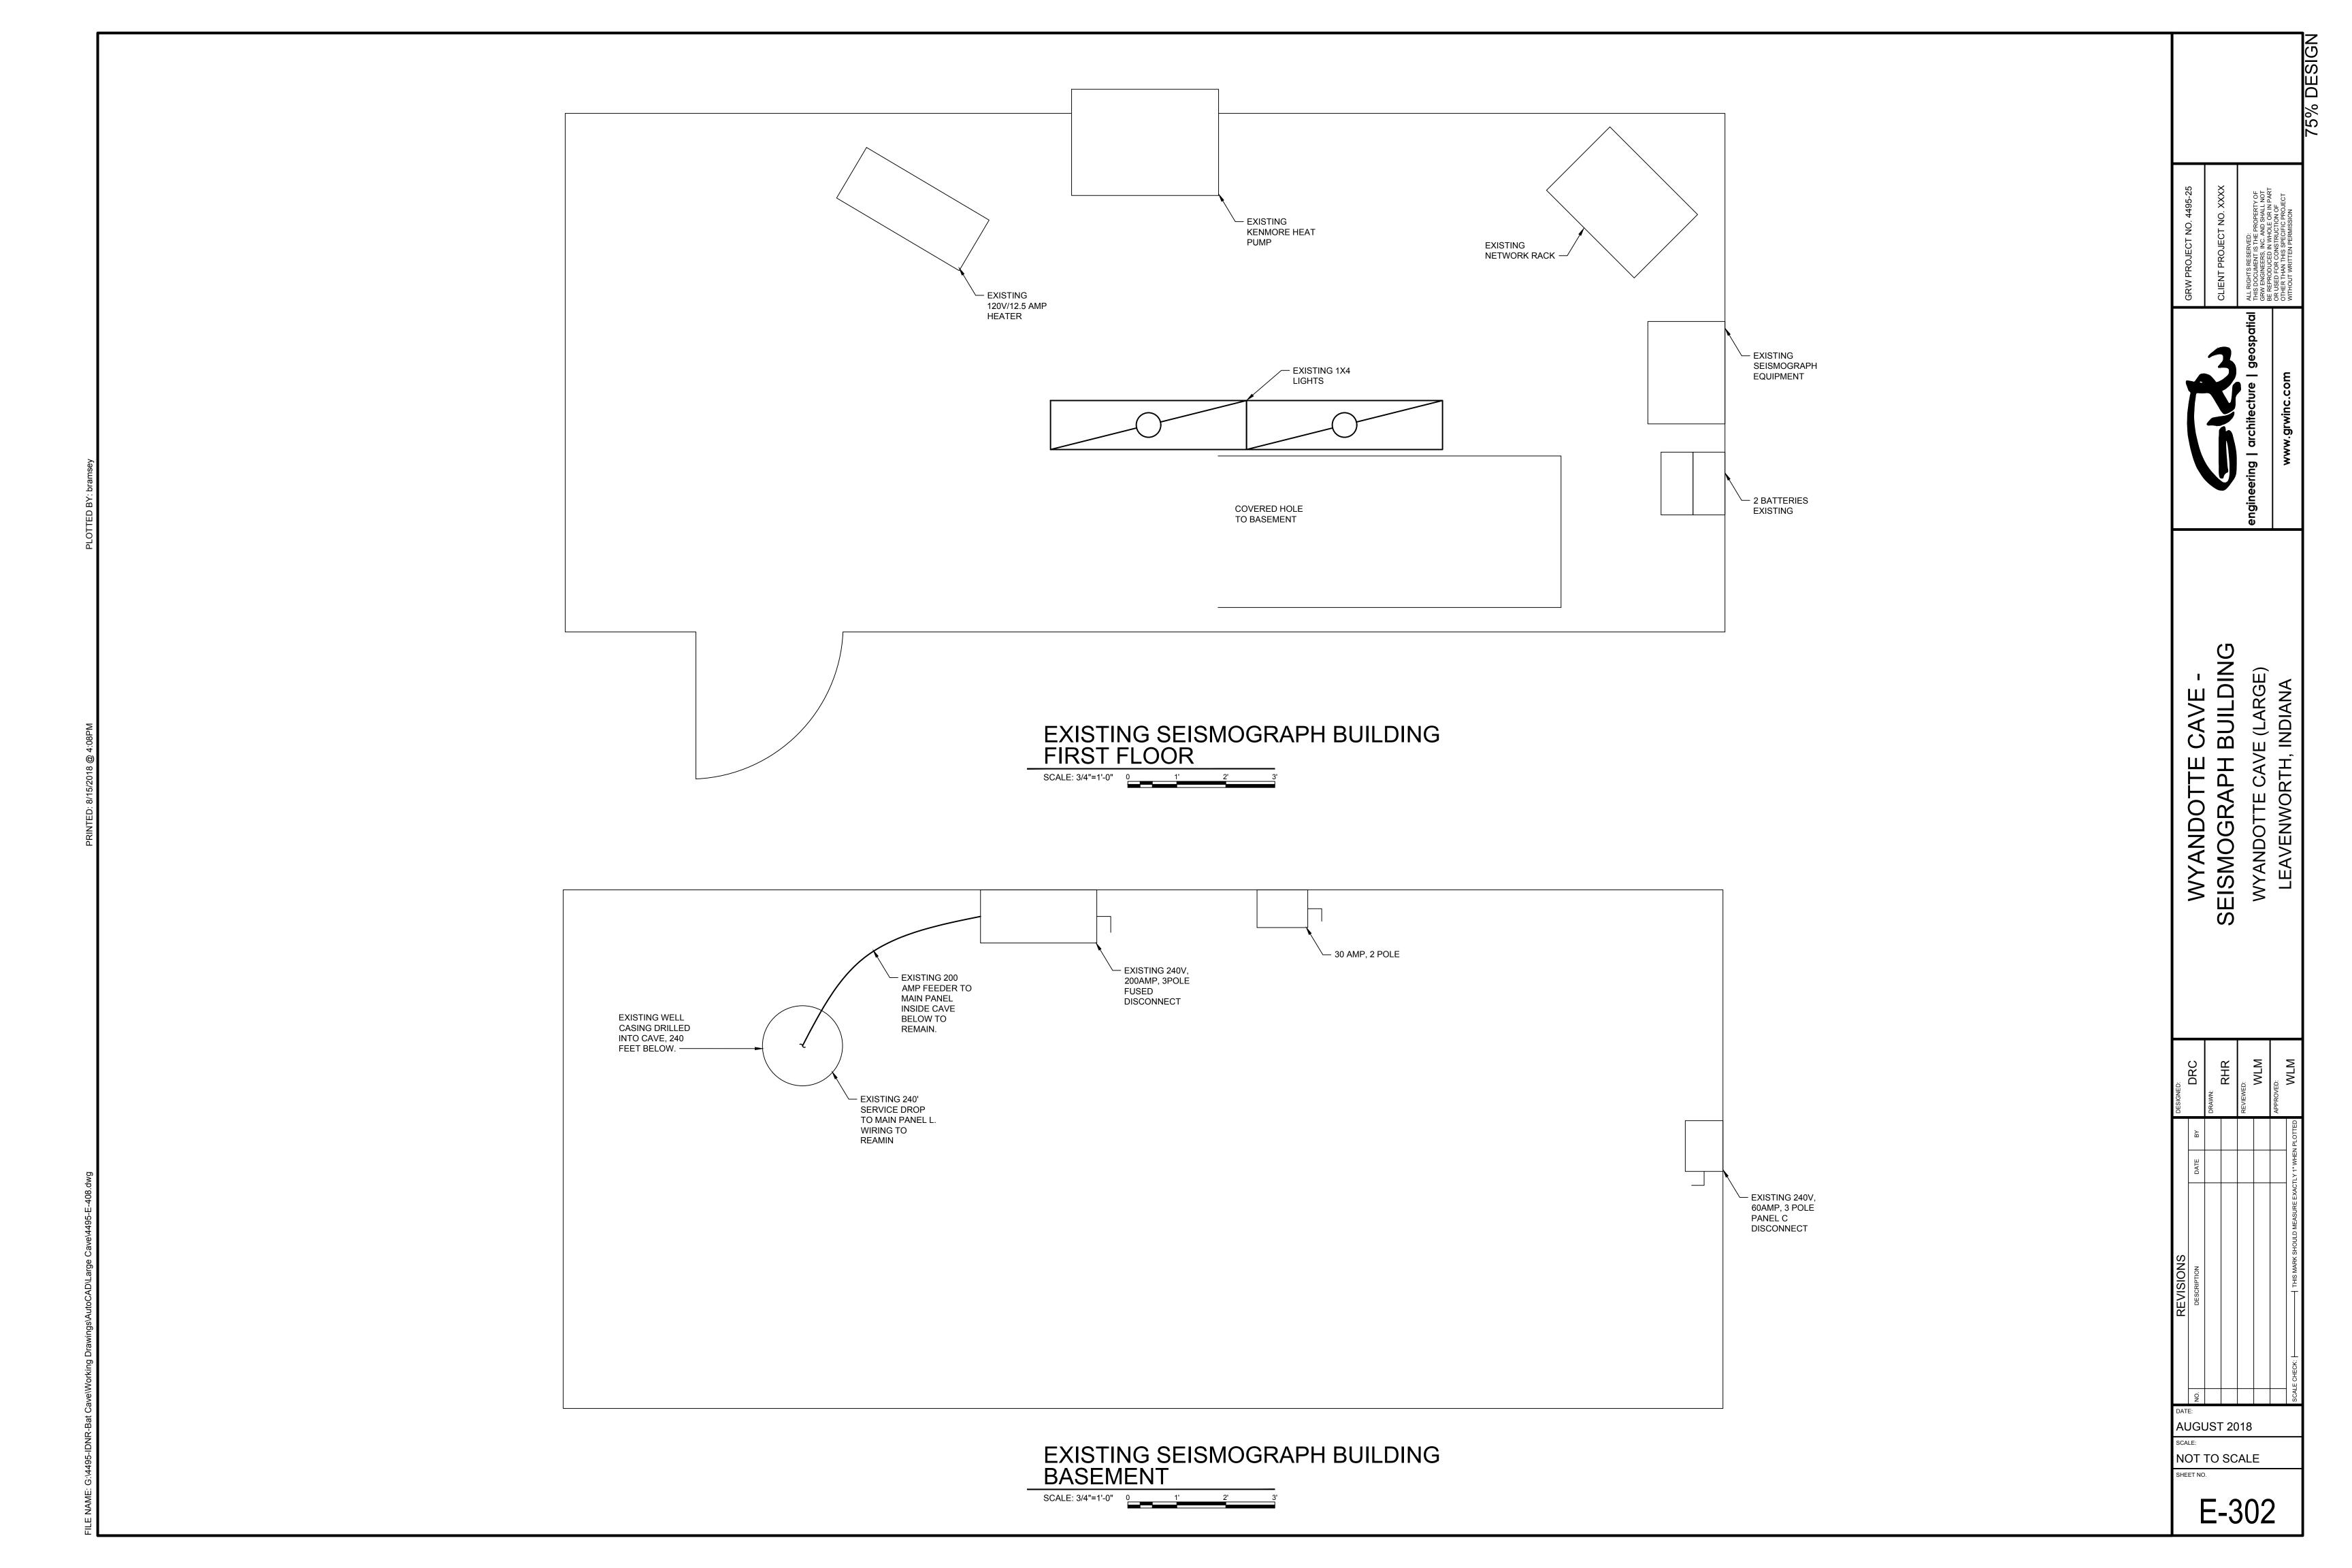


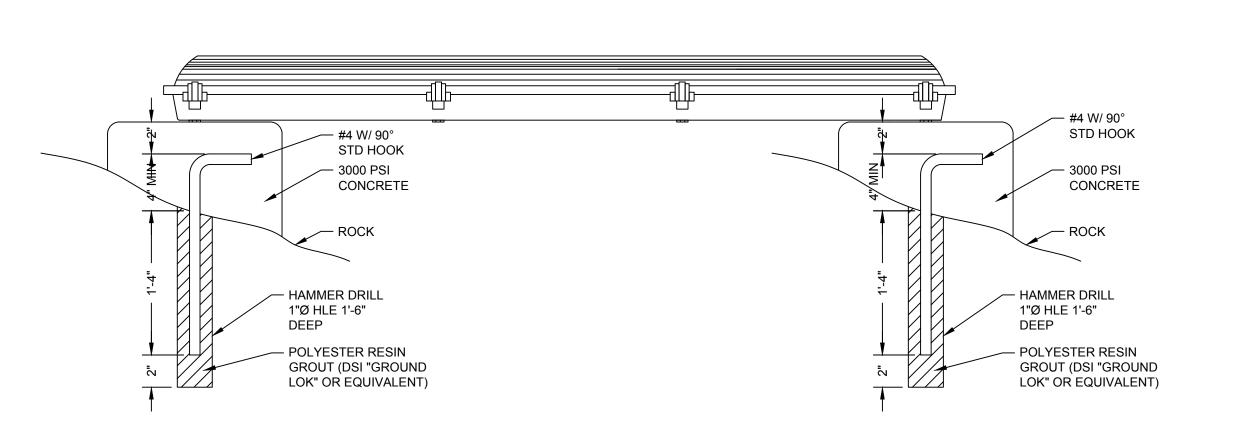




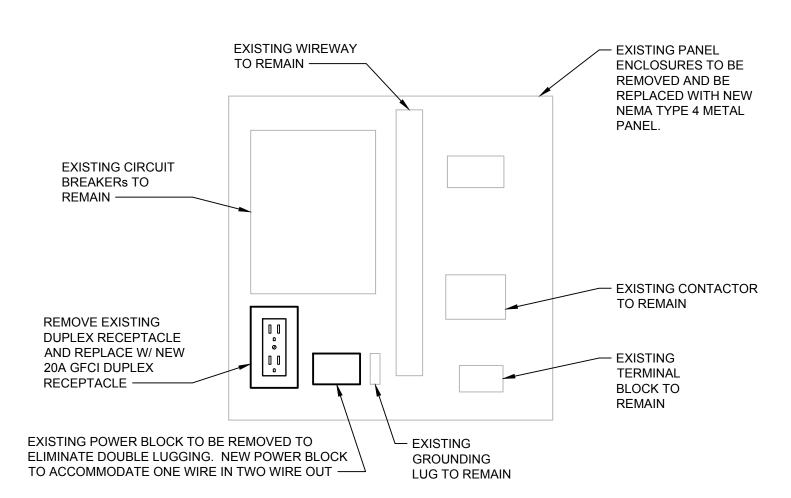




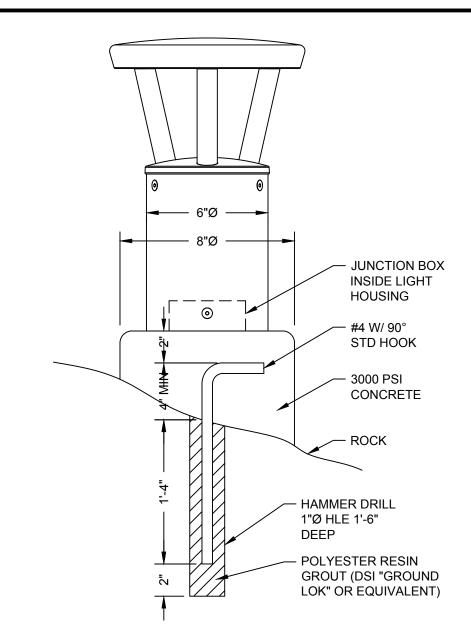


NEW LIGHT FIXTURE
TYPE "B" MOUNTING DETAIL

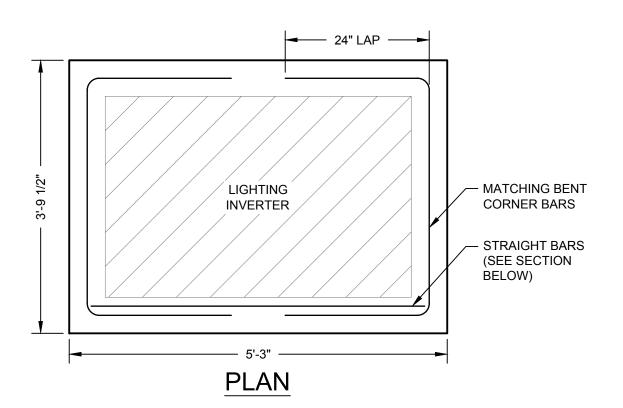

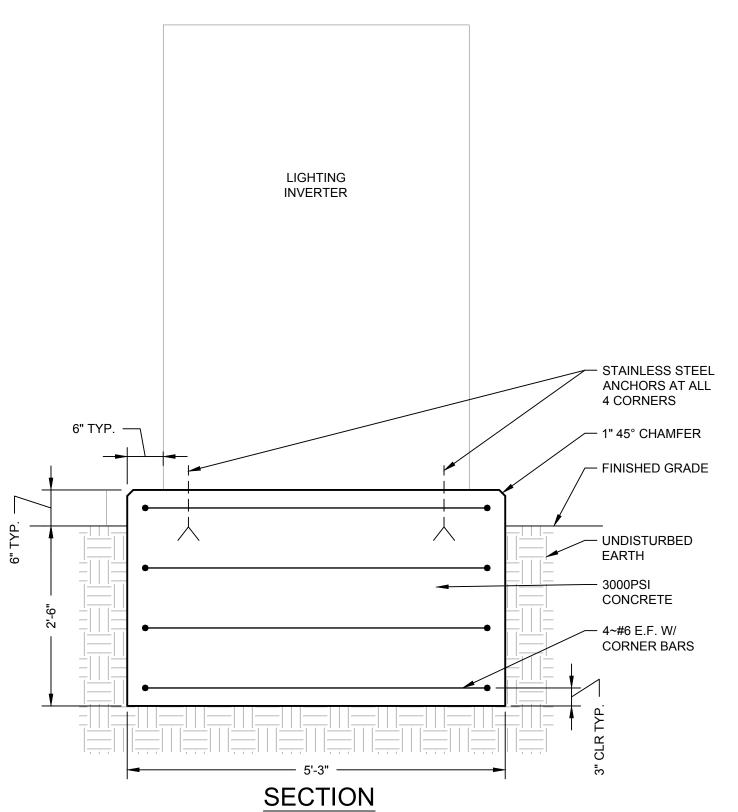


NEW CENTRAL LIGHTING INVERTER FOUNDATION DETAIL

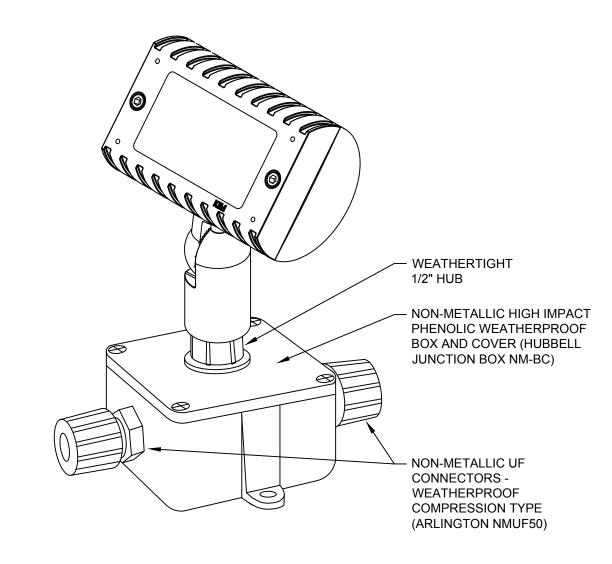

NEW LIGHT FIXTURE
TYPE "C" MOUNTING DETAIL

NOT TO SCALE

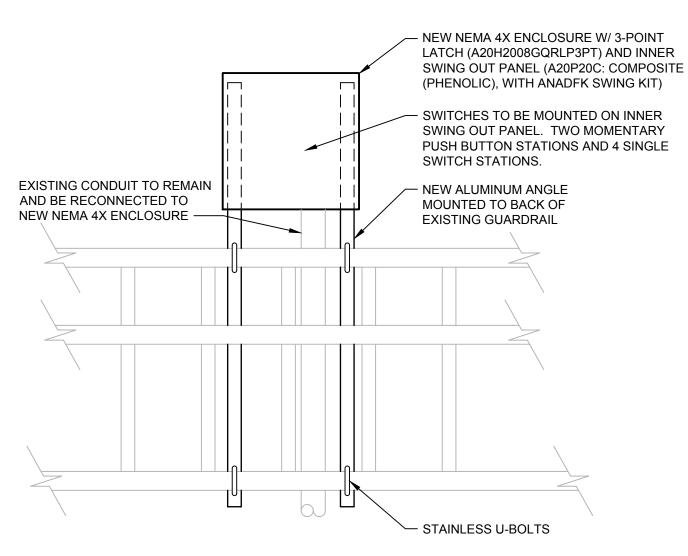

6 TYPICAL NEW SWITCH STATION

NOTE: MODEL NUMBERS ARE HOFFMAN/PENTAIR.

GRW PROJECT NO. 4495-25

CLIENT PROJECT NO. XXXX

CLIENT PROJECT NO. XXXX

ALL RIGHTS RESERVED:
THIS DOCUMENT IS THE PROPERTY OF GRW ENGINEERS, INC. AND SHALL NOT BE REPRODUCED IN WHOLE OR IN PART ON USED FOR CONSTRUCTION OF THE THAN THIS SPECIFIC PROJECT

gineering | architecture | geospat

ELECTRICAL DETAILS
WYANDOTTE CAVE (LARGE)


SCRIPTION DATE BY DRAWN:
RHR
REVIEWED:
WLM
HTHIS MARK SHOULD MEASURE EXACTLY 1" WHEN PLOTTED
WLM

DATE:
AUGUST 2018
SCALE:
NOT TO SCALE



#### **GENERAL NOTES:**

- 1. UNDERGROUND CONDUIT FROM THE SERVICE RISER POLE TO THE CAVE SHALL BE SCHEDULE 40 PVC.
- 2. MOUNT SPD TO SERVICE POLE.

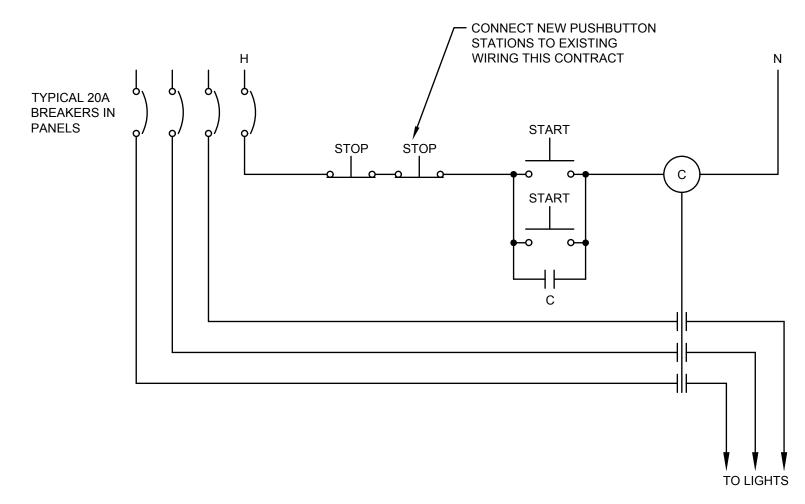

TYPICAL WIRING FOR PUSHBUTTON LIGHTING CONTROL STATIONS

NOT TO SCALE

ELECTRICAL DETA
WYANDOTTE CAVE (LAR


DRC		DRAWN:	RHR	REVIEWED:	WLM	APPROVED: WLM		
	ЬВ						N PLOTTED	
	DATE						'LY 1" WHEN	
KEVISIONS	DESCRIPTION						∷ ├────────────────────────────────────	

AUGUST 2018
SCALE:
NOT TO SCALE

FIXTURE	IXTURE DESCRIPTION		LUMEN SOURCE					MOUNTING		MANUFACTURER	MODEL NUMBER	
TYPE	TYPE	COLOR TEMP	TYPE	LUMENS	WATTS	VOLTS	TYPE	HEIGHT	QUANITY	MANOI ACTORER	MODEL NOMBER	
Α	1X8 LED LXEM	3000K	LED	8,095	66.6	120	GROUND	N/A	34	COLUMBIA LIGHTING	LXEM8-30LW-RFA-EU-DWH-XEDPM	
В	14" BOLLARD LED FIXTURE	3000K	LED	950	10	120	GROUND	N/A	77	FIRST LIGHT TECHNOLOGIES	PLB-AC-BZ-FT-30K-UV7	
С	DIRECTIONAL FLOOD LED FIXTURE	3000K	LED	4,320	38	120	GROUND	N/A	24	KIM LIGHTING	EL218-W-3-8L-3K-UV-DB	
D	LED STEP LIGHT	3000K	LED	167	11.5	120	WALL INSERT	12"	2	KIM LIGHTING	EL807/9L3KUV	

	ALT. 2 NEW LIGHT FIXTURE SCHEDULE													
FIXTURE	DESCRIPTION	LUMEN SOURCE					MC	DUNTING	QUANITY	MANUFACTURER	MODEL NUMBER			
TYPE	DESCRIPTION	COLOR TEMP	TYPE	LUMENS	WATTS	VOLTS  -	TYPE	HEIGHT	QUANITI	WANDI ACTORER	MODEL NOMBER			
А	1X8 LED LXEM	3000K	LED	8,095	66.6	120	GROUND	N/A	80	COLUMBIA LIGHTING	LXEM8-30LW-RFA-EU-DWH-XEDPM			
В	14" BOLLARD LED FIXTURE	3000K	LED	950	10	120	GROUND	N/A	31	FIRST LIGHT TECHNOLOGIES	PLB-AC-BZ-FT-30K-UV7			
С	DIRECTIONAL FLOOD LED FIXTURE	3000K	LED	4,320	38	120	GROUND	N/A	23	KIM LIGHTING	EL218-W-3-8L-3K-UV-DB			
Е	12' LED POLE LIGHT	3000K	LED	7792	74.8	120	POLE	12'	6	STRUCTURA	EVO-12-A12-LIN-16-LIN-P1/S-MOD			


ALT. 1 NEW LIGHT FIXTURE SCHEDULE													
FIXTURE	DESCRIPTION	LUMEN SOURCE				VOLTS -	MOUNTING		QUANITY	MANUFACTURER	MODEL NUMBER		
TYPE	DESCRIPTION	COLOR TEMP	TYPE	LUMENS	WATTS	VOLIS	TYPE	HEIGHT	QUANTI	IVIANOI ACTORER	MODEL NOMBEN		
Α	1X8 LED LXEM	3000K	LED	8,095	66.6	120	GROUND	N/A	65	COLUMBIA LIGHTING	LXEM8-30LW-RFA-EU-DWH-XEDPM		
В	14" BOLLARD LED FIXTURE	3000K	LED	950	10	120	GROUND	N/A	83	FIRST LIGHT TECHNOLOGIES	PLB-AC-BZ-FT-30K-UV7		
С	DIRECTIONAL FLOOD LED FIXTURE	3000K	LED	4,320	38	120	GROUND	N/A	70	KIM LIGHTING	EL218-W-3-8L-3K-UV-DB		

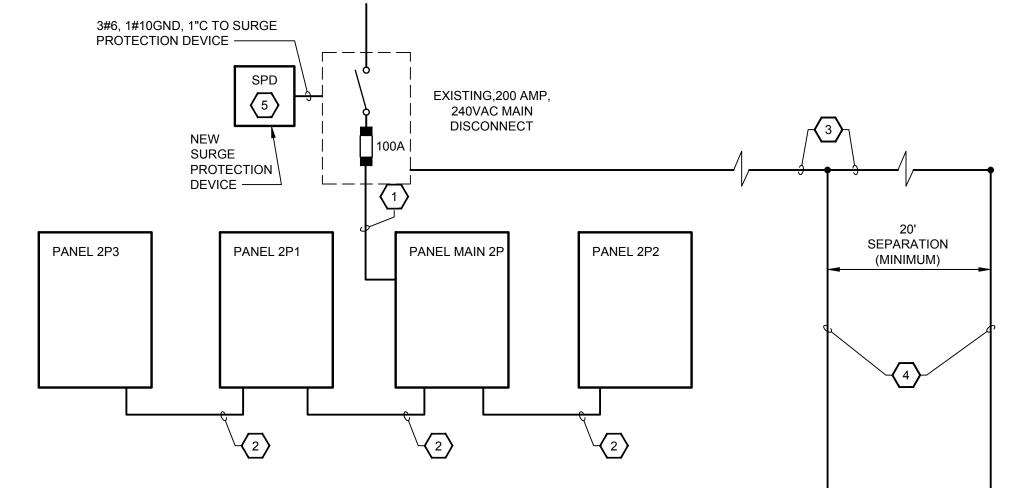



#### 


- EXISTING WIRE AND CONDUIT TO REMAIN.
- 2. 3#4, 1#6GND UF CABLE
- 3. NEW BARE #2 COPPER BURIED 30".
- 4. DRIVE ALL RODS TO 30" BELOW GRADE (INCLUDING EXISTING ROD).
- 5. FURNISH AND INSTALL A NEW TYPE 2 SPD THIS CONTRACT.

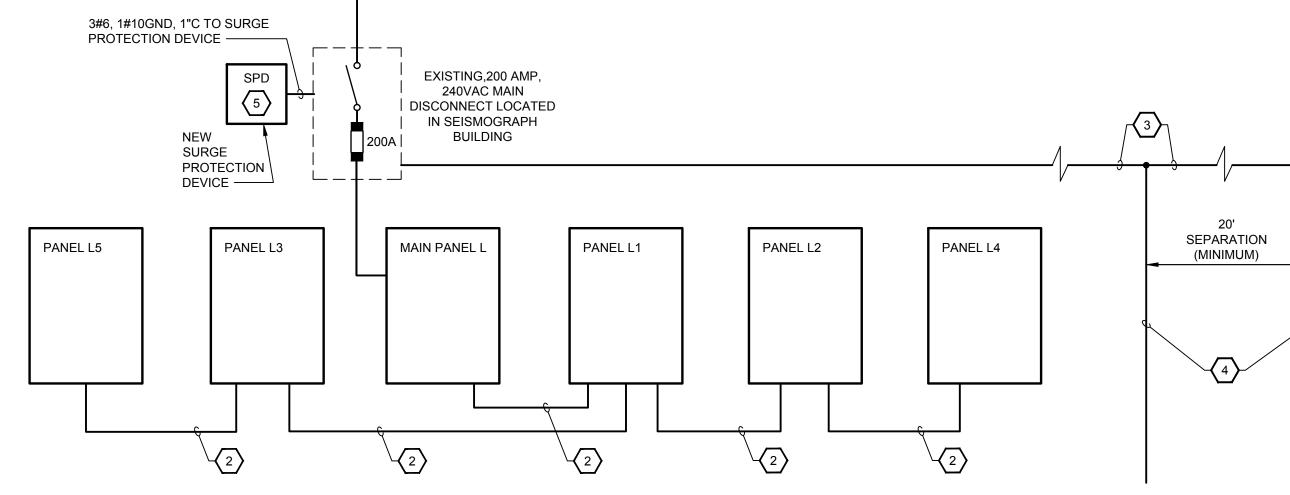

ALT. 1 ONE LINE

#### ○ KEYNOTES TO ONE LINE DIAGRAMS:

- 1. EXISTING WIRE AND CONDUIT TO REMAIN.
- 2. 3#4, 1#6GND UF CABLE
- 3. NEW BARE #2 COPPER BURIED 30".
- 4. DRIVE ALL RODS TO 30" BELOW GRADE (INCLUDING EXISTING ROD).
- 5. FURNISH AND INSTALL A NEW TYPE 2 SPD THIS CONTRACT.

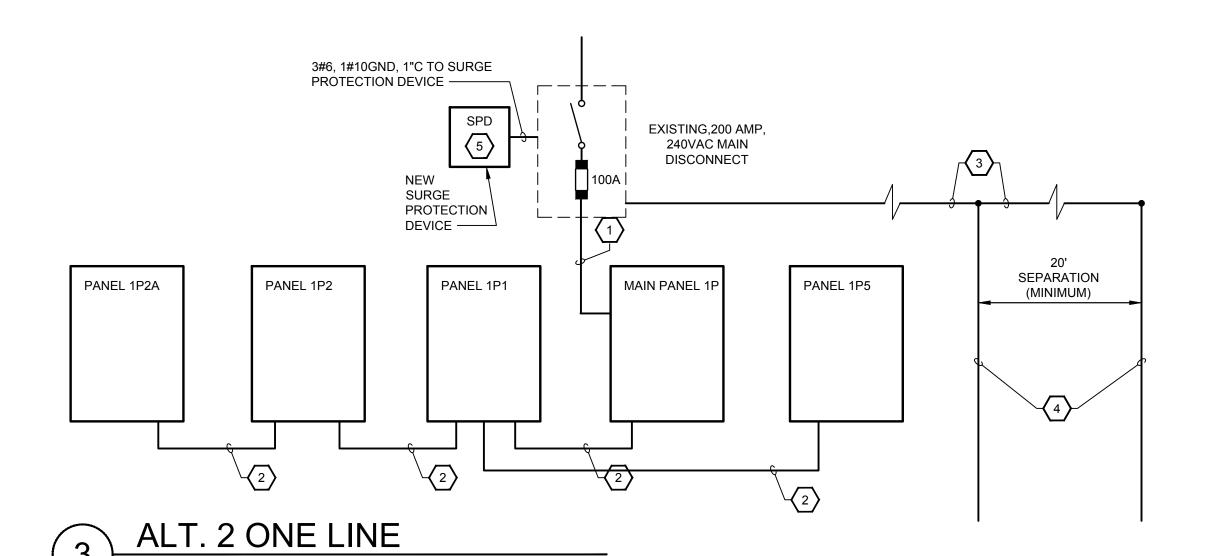

## ○ KEYNOTES TO ONE LINE DIAGRAMS:

- 1. EXISTING WIRE AND CONDUIT TO REMAIN.
- 2. 3#4, 1#6GND UF CABLE
- 3. NEW BARE #2 COPPER BURIED 30".
- 4. DRIVE ALL RODS TO 30" BELOW GRADE (INCLUDING EXISTING ROD).
- 5. FURNISH AND INSTALL A NEW TYPE 2 SPD THIS CONTRACT.

AUGUST 2018